### **Washoe County Development Application**

Your entire application is a public record. If you have a concern about releasing personal information, please contact Planning and Building staff at 775.328.6100.

| Project Information S  |                         | Staff Assigned Case No.:            |                 |  |  |
|--|-------------------------|-------------------------------------|-----------------|--|--|
| Project Name:  |                         |                                     |                 |  |  |
| Project<br>Description:  |                         |                                     |                 |  |  |
| Project Address:   |                         |                                     |                 |  |  |
| Project Area (acres or square fe   | et):                    |                                     |                 |  |  |
| Project Location (with point of re   | eference to major cross | s streets <b>AND</b> area locator): |                 |  |  |
| Assessor's Parcel No.(s):  | Parcel Acreage:         | Assessor's Parcel No.(s):           | Parcel Acreage: |  |  |
|  |                         |                                     |                 |  |  |
|  |                         |                                     |                 |  |  |
| Indicate any previous Washoe County approvals associated with this application: Case No.(s). |                         |                                     |                 |  |  |
| Applicant Inf  | ormation (attach        | additional sheets if necess         | sary)           |  |  |
| Property Owner:  |                         | Professional Consultant:            |                 |  |  |
| Name:  |                         | Name:                               |                 |  |  |
| Address:   |                         | Address:                            |                 |  |  |
| Zip:   |                         | Zip:                                |                 |  |  |
| Phone: Fax:  |                         | Phone: Fax:                         |                 |  |  |
| Email:   |                         | Email:                              |                 |  |  |
| Cell: Other:   |                         | Cell: Other:                        |                 |  |  |
| Contact Person:  |                         | Contact Person:                     |                 |  |  |
| Applicant/Developer:   |                         | Other Persons to be Contacted:      |                 |  |  |
| Name:  |                         | Name:                               |                 |  |  |
| Address:   |                         | Address:                            |                 |  |  |
| Zip:   |                         |                                     | Zip:            |  |  |
| Phone: Fax:  |                         | Phone: Fax:                         |                 |  |  |
| Email:   |                         | Email:                              |                 |  |  |
| Cell:  | Other:                  | Cell:                               | Other:          |  |  |
| Contact Person:  |                         | Contact Person:                     |                 |  |  |
|  | For Office              | e Use Only                          |                 |  |  |
| Date Received: Initial: F  |                         | Planning Area:                      |                 |  |  |
| County Commission District:  |                         | Master Plan Designation(s):         |                 |  |  |
| CAB(s):  |                         | Regulatory Zoning(s):               |                 |  |  |

### **Property Owner Affidavit**

| Applicant Name: Jeremy S Munoz   |
|--|
| The receipt of this application at the time of submittal does not guarantee the application complies with all  |
| requirements of the Washoe County Development Code, the Washoe County Master Plan or the applicable area plan, the applicable regulatory zoning, or that the application is deemed complete and will be processed.   |
| STATE OF NEVADA )  |
| COUNTY OF WASHOE )   |
| To some Minage   |
| I, Terem Muno.  (please print name)  |
| being duly sworn, depose and say that I am the owner* of the property or properties involved in this application as listed below and that the foregoing statements and answers herein contained and the information herewith submitted are in all respects complete, true, and correct to the best of my knowledge and belief. I understand that no assurance or guarantee can be given by members of Planning and Building. |
| (A separate Affidavit must be provided by each property owner named in the title report.)  |
| Assessor Parcel Number(s): 009-111-15  |
| Printed Name Verenny Munos   |
| Signed   |
| Address 215 Goose barry I  |
|  |
| Subscribed and sworn to before me this 24 day of Suphalar 2022.  William ANTONITSCH Notary Public - State of Nevada County of Washoe APPT. NO. 21-8326-02 My App. Expires Mar. 11, 2025  |
| My commission expires: 03/11/2025  |
| *Owner refers to the following: (Please mark appropriate box.)   |
| ■ Owner  |
| <ul> <li>Corporate Officer/Partner (Provide copy of record document indicating authority to sign.)</li> </ul>  |
| □ Power of Attorney (Provide copy of Power of Attorney.)   |
| <ul> <li>Owner Agent (Provide notarized letter from property owner giving legal authority to agent.)</li> </ul>  |
| ☐ Property Agent (Provide copy of record document indicating authority to sign.)   |
| □ Letter from Government Agency with Stewardship   |


### **Administrative Review Permit Application** for a Detached Accessory Dwelling **Supplemental Information**

(All required information may be separately attached)

| 1. | What is the size (square footage) of the main dwelling or proposed main dwelling (exclude size or garage)?   |
|----|--|
| 2. | What is the size of the proposed detached accessory dwelling (exclude size of garage)? If a manufactured or modular home is the secondary dwelling, list the age and size of the unit.   |
| 3. | How are you planning to integrate the main dwelling and secondary dwelling to provide architectura   |
| O. | compatibility of the two structures?   |
| 5. | How many off-street parking spaces are available? Parking spaces must be shown on site plan. Are any new roadway, driveway, or access improvements be required?  |
|    |  |
| 6. | What will you do to minimize any potential negative impacts (e.g. increased lighting, removal or existing vegetation, etc.) your project may have on adjacent properties?  |
|    |  |
| 7. | Is the subject property part of an active Home Owners Association (HOA) or Architectural Contro Committee?   |
|    | ☐ Yes ☐ No If yes, please list the HOA name.   |
| 8. | Are there any restrictive covenants, recorded conditions, or deed restrictions (CC&Rs) that may prohibit a detached accessory dwelling on your property?   |
|    | ☐ Yes ☐ No If yes, please attach a copy.   |
| 9. | Only one accessory dwelling unit, whether attached or detached, is allowed per parcel. Is there a guest apartment, mother-in-law unit, next-gen addition with kitchen or any other type of secondary dwelling on the subject property? |
|    | ☐ Yes ☐ No If yes, please provide information on the secondary unit.   |
|    |  |

10. List who the service providers are for the main dwelling and accessory dwelling:


|                              | Main Dwelling | Accessory Dwelling |
|------------------------------|---------------|--------------------|
| Sewer Service                |               |                    |
| Electrical Service           |               |                    |
| Solid Waste Disposal Service |               |                    |
| Water Service                |               |                    |

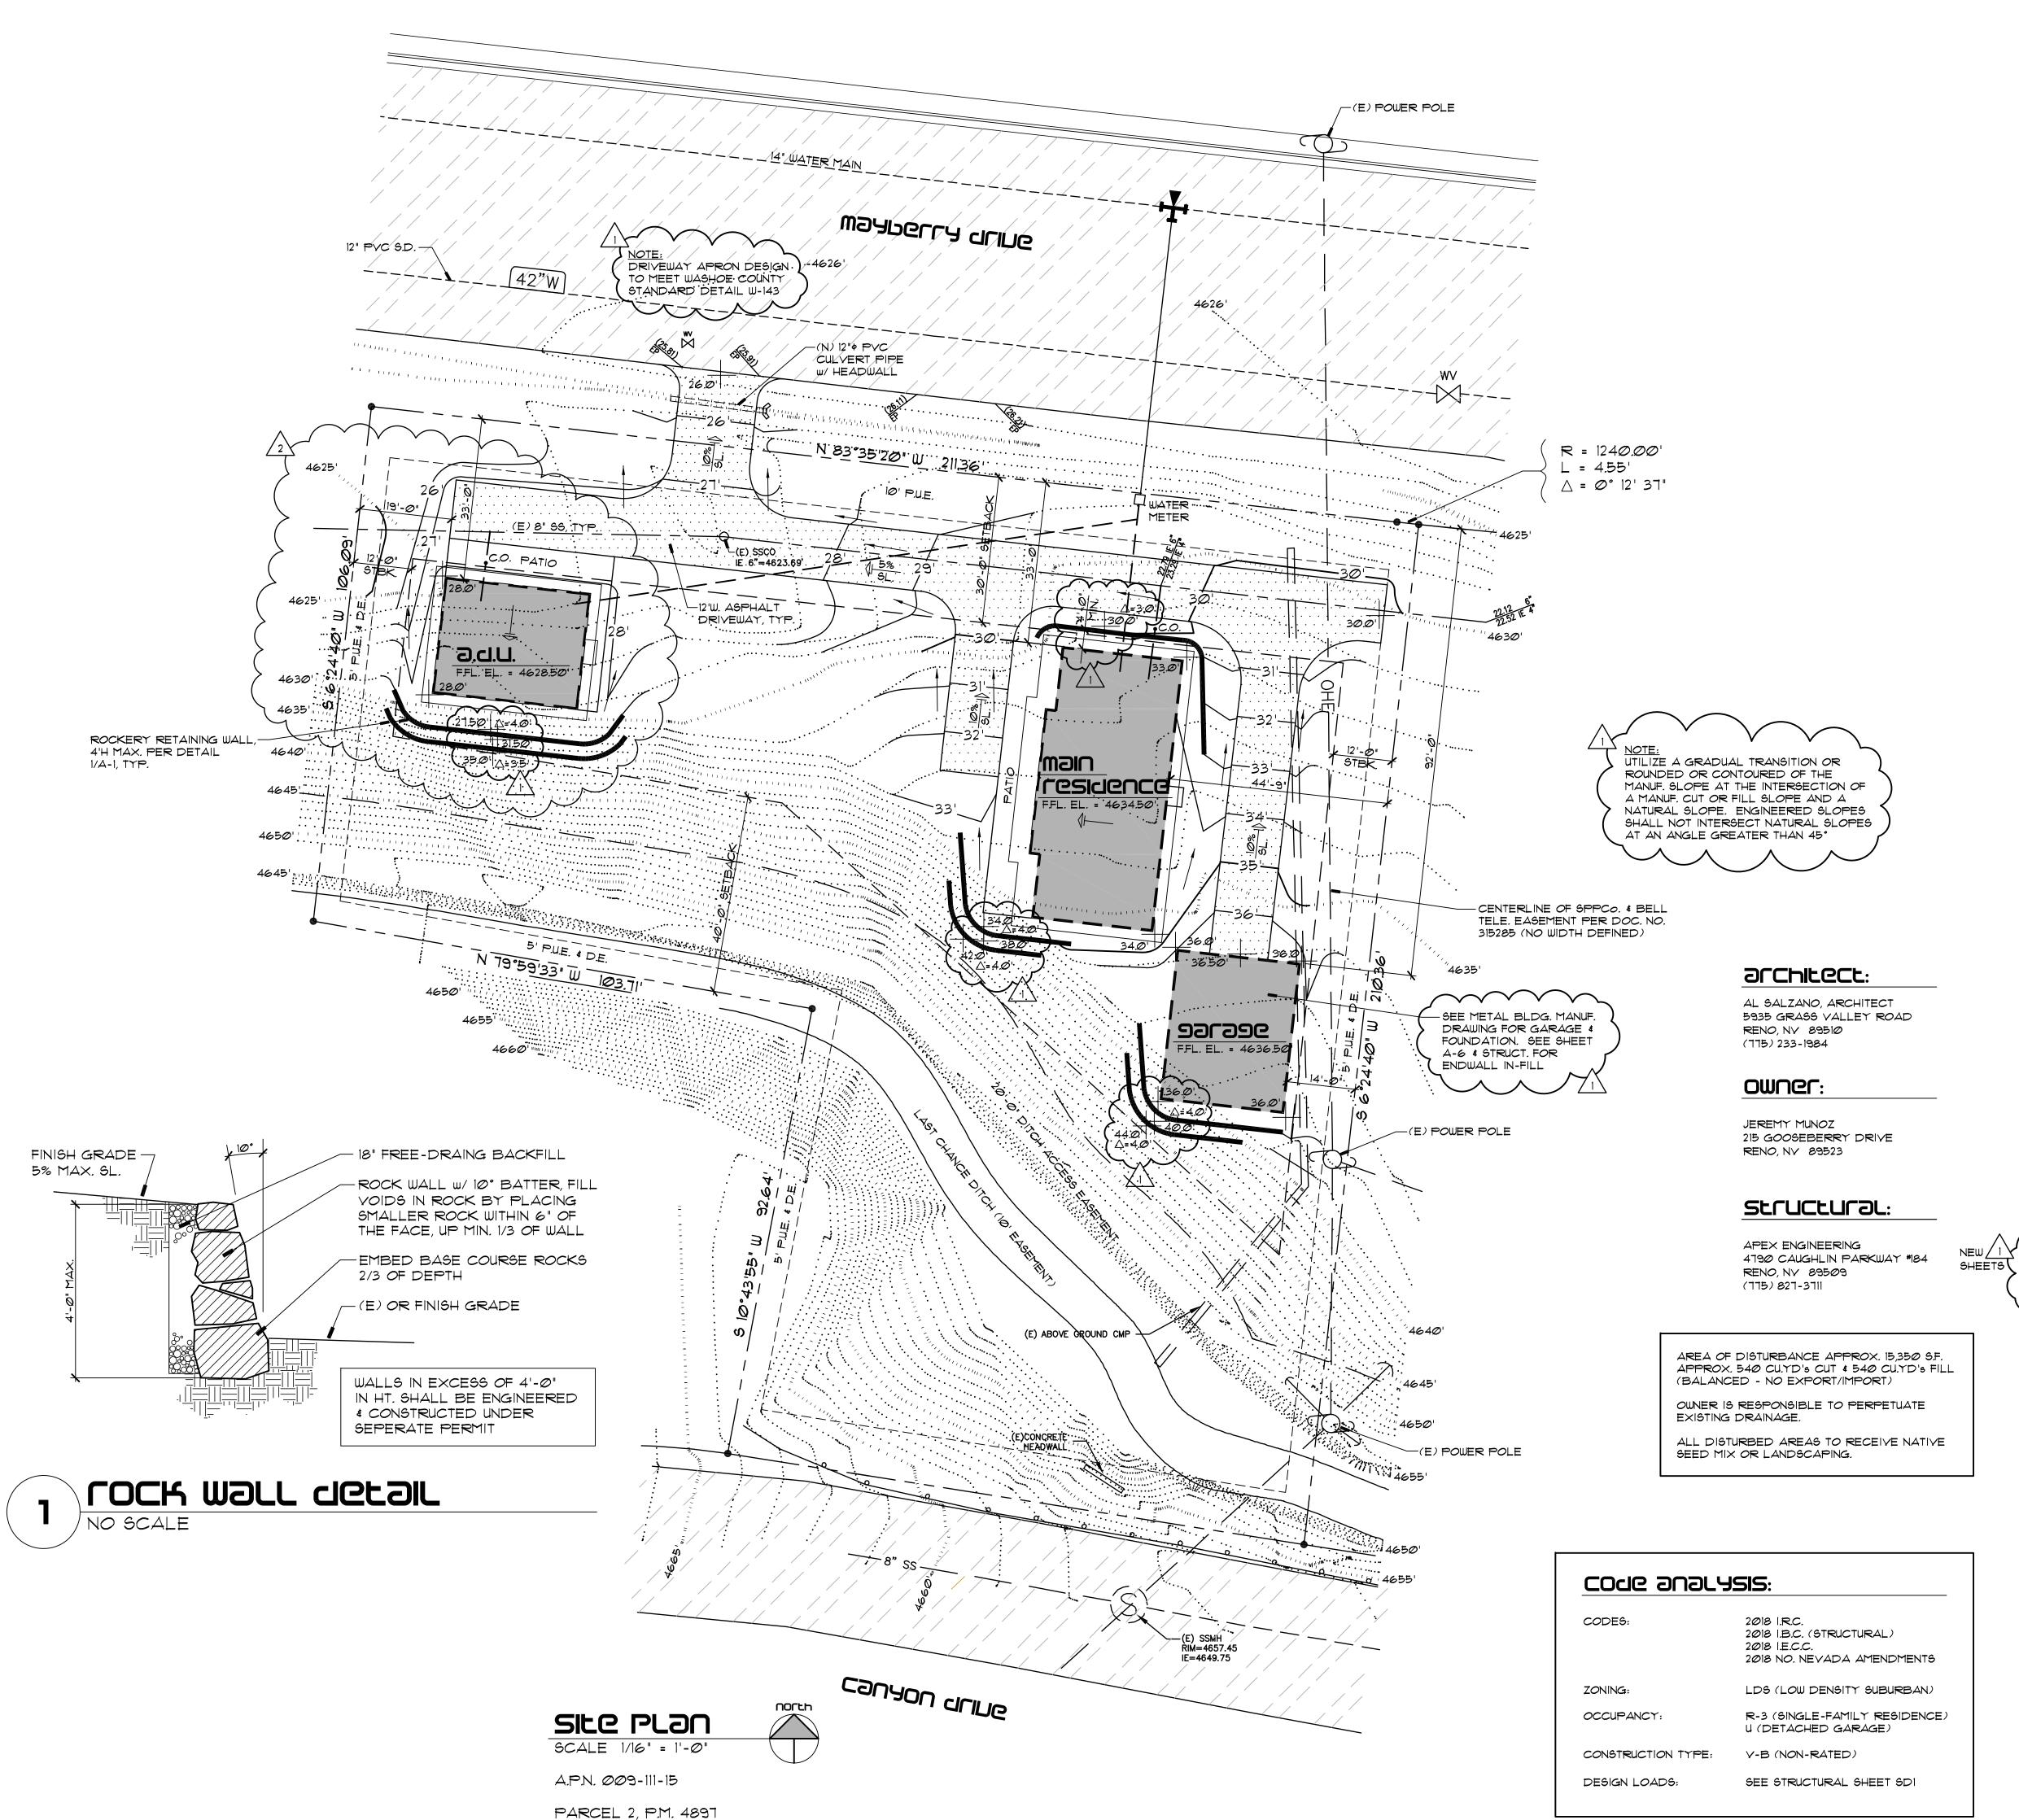

### Severar votes:

- ALL CONSTRUCTION SHALL MEET THE CURRENT REQUIREMENTS OF THE I.R.C., WASHOE COUNTY BUILDING & PLANNING DEPARTMENTS & ANY APPLICABLE C.C. &R. 'S WITHIN THIS DEVELOPMENT.
- 2. FIELD VERIFY EXISTING SITE GRADES AND CONDITIONS.
- 3. FIELD VERIFY ALL UTILITY LOCATIONS -CONNECTIONS SHALL BE MADE IN ACCORDANCE WITH ALL APPLICABLE CODES & REQUIREMENTS.
- 4. ALL PREFABRICATED PRODUCTS SHALL BE INSTALLED PER MANUF. SPECIFICATIONS.
- PROPERTY IS LOCATED IN A 'MODERATE FIRE HAZARD' WILDLAND URBAN INTERFACE (W.U.I.) ZONE, SEE SHEET A-5 FOR W.U.I. REQUIREMENTS & NOTES.

### SILE LESENd:

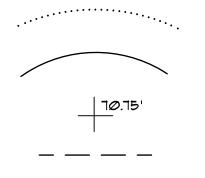

EXISTING CONTOURS

FINISH CONTOURS

FINISH GRADES

DRAINAGE SLOPE - 2% MIN.

BUILDING ENVELOPE LINES

### SILE NOLES:

- SOILS ENGINEER SHALL EXAMINE SITE AFTER EXCAYATION AND PRIOR TO SETTING ANY CONC. FORMS. SOIL'S ENGINEER RECOMMENDATIONS CONCERNING FOOTING SIZE, DEPTH, COMPACTION, ETC. SHALL BE FOLLOWED.
- 2. DRIVEWAY SHALL BE 21/2" TYPE-III AC-20 ASPHALT PAVEMENT OVER 6" TYPE.-II BASE COMPACTED TO 95%.
- 3. ALL WALKS & PATIOS NOTED ON SITE PLAN SHALL BE 4" CONC. W/ FIBER MESH OVER 6" TYPE.-11 BASE COMPACTED TO 95%.
- 4. CARE SHALL BE TAKEN THAT ALL VEGETATION IN UNDEVELOPED AREAS IS PROTECTED DURING CONSTRUCTION. ALL VEHICLES & MATERIAL STORAGE SHALL BE RESTRICTED TO DRIVE AREA.
- 5. RETAIN ALL STONES FROM EXCAVATION. LARGER BOULDERS SHALL BE PLACED RANDOMLY IN PLANTER AREAS.
- 6. GRADE SITE TO DRAIN 5% MIN. FOR 10'-0" AWAY FROM RESIDENCE.

|             | arawina iuagk                 |
|-------------|-------------------------------|
| <b>△</b> -1 | SITE PLAN, DRAWING INDEX      |
| A-2         | FLOOR PLANS                   |
| A-3         | EXTERIOR ELEV MAIN HOUSE      |
| A-4         | EXTERIOR ELEVATIONS - A.D.U.  |
| A-5         | BUILDING SECTIONS             |
| A-6         | DETACHED GARAGE ELEV. & ELEC. |
| QS1         | DETACHED GARAGE ENDWALLS      |
| S1          | FOUNDATION PLANS & DETAILS    |
| <b>S</b> 2  | ROOF FRAMING PLANS & DETAILS  |
| SØ.1        | STRUCTURAL NOTES              |
| SØ.2        | STRUCTURAL DETAILS            |
| ME-         | MECH./ELEC. PLANS             |
| 1 of 1      | GARAGE DRAWING                |
|             |                               |

APPROVALS:

architect

5995 9fass valley foad reno, nevada 89510 775.299.1984 Cell ajsalzano @ aol.com www.alsalzano.com



SS-8-F revisions.

> 9-8-22 1 \ PLANCHECK

12-5-22 /2 ADU SIZE REDUCTION


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Drawing title

SITE PLAN, COVER SHEET

Drawings is prohibited.



FLOOR PLON SCALE 1/4" = 1'-0"

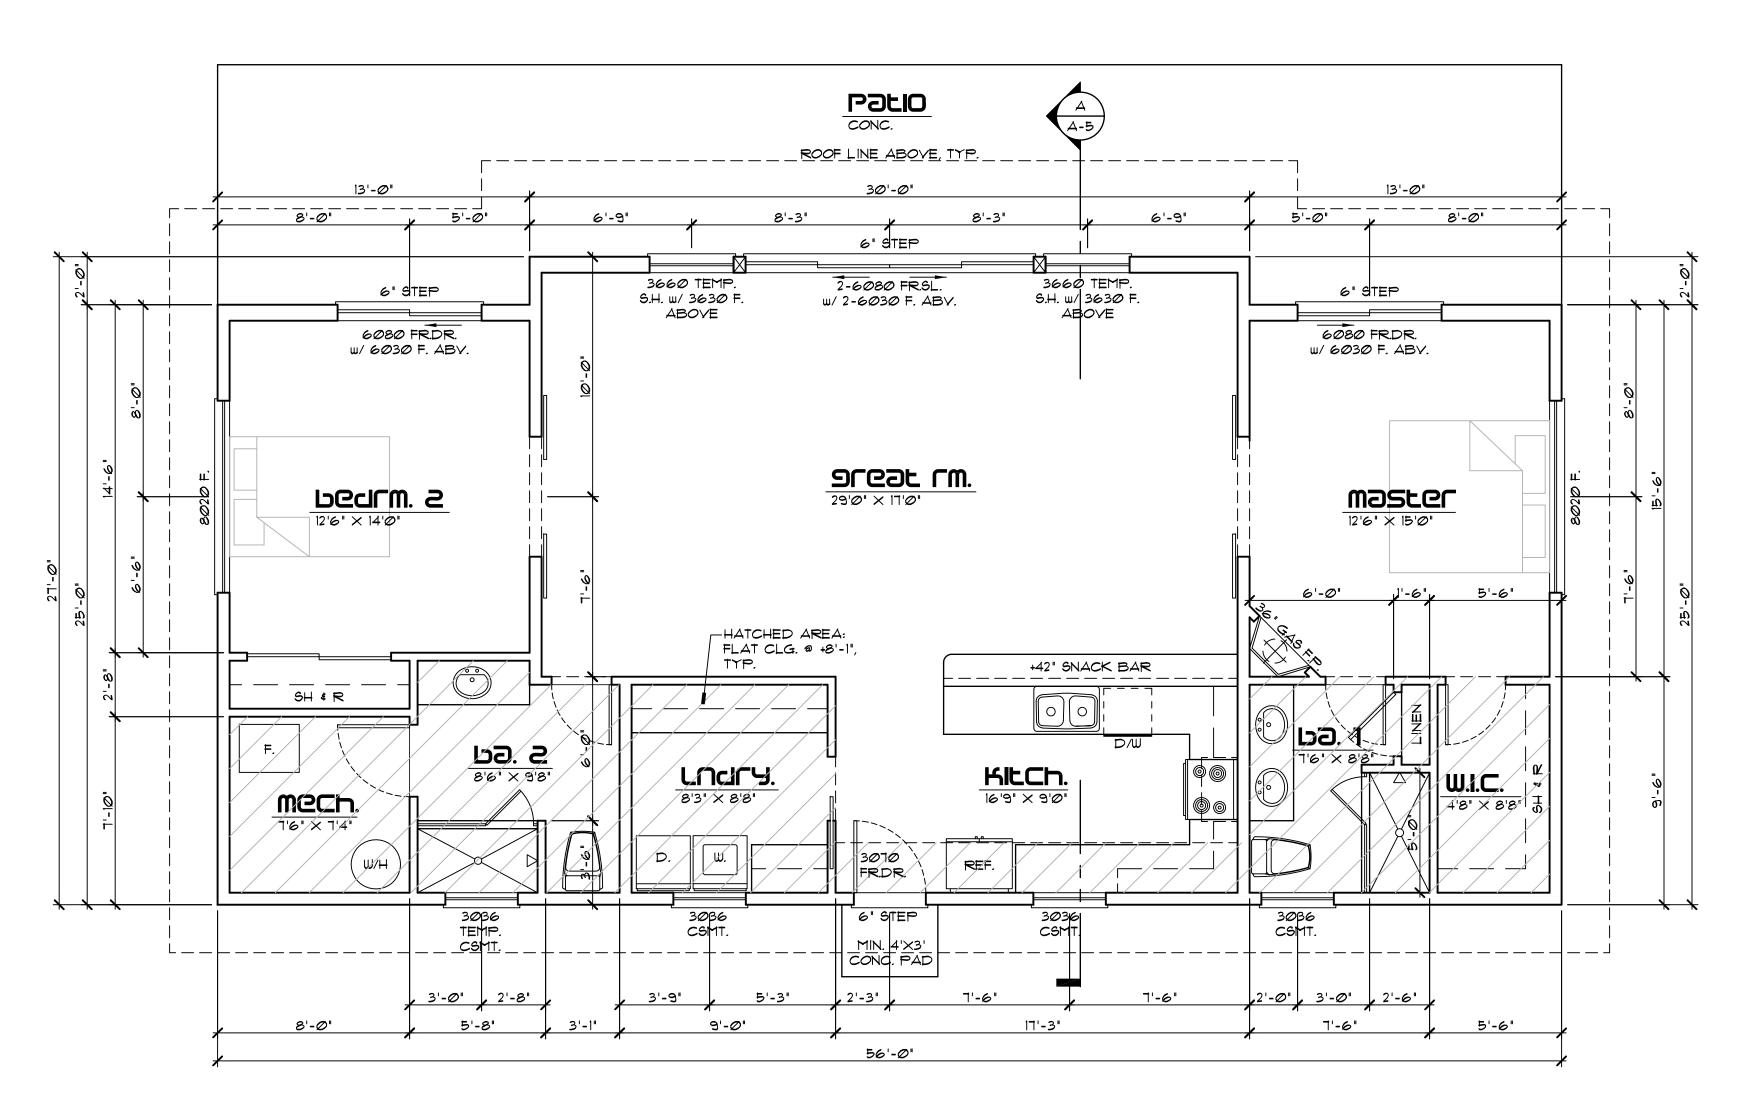LIVABLE AREA APPROX. 1,460 SQ.FT.

### FLOOF PLON NOTES:

- 1. EXTERIOR WALLS SHALL BE 2X6 STUDS @ 16" O.C. w/ MIN. 1/2" CDX PLYWD. (OR EQUAL) SHEATHING (1/8" GAP @ ALL EDGES), VAPOR BARRIER & R-21 INSUL., TYP. INTERIOR NON-BEARING WALLS SHALL BE 2×4 @ 16" O.C. U.N.O. PROVIDE FOAM SILL SEAL @ ALL EXTERIOR WALLS.
- 2. 1/2" G.W.B. @ WALLS & 5/8" G.W.B. @ CEILINGS TYP. USE TILE BACKER BD. IN WET AREA. DRYWALL CORNERS & TEXTURE PER OWNER.
- 3. SEE FOUNDATION PLAN FOR ADDITIONAL DIMENSIONS.
- 4. TYPICAL PLATE HEIGHT IS 9'-1" A.F.F. (U.N.O.): WINDOW HEADER HEIGHT IS 7'-0" A.F.F. (U.N.O.): INTERIOR DOOR HEIGHT IS 8'-0" A.F.F. (U.N.O.)
- 5. ALL CEILING FRAMING SHALL BE @ 24" O.C. AS FOLLOWS: 2×4'S MAX. SPAN 9'-0" 2×6'S MAX. SPAN 14'-0" 2×8'S MAX. SPAN 18'-6"
- 6. WHERE POSSIBLE VENT PLUMBING & FLUES TO REAR OF RESIDENCE.
- 7. SEE EXTERIOR ELEVATIONS FOR SPECIALTY WINDOWS. ALL GLAZING SHALL BE LOW-E COATED, DUAL GLAZED.
- 8. PROVIDE SILL PANS @ ALL EXTERIOR DOORS & WINDOWS.
- 9. PROVIDE CIRCULATION PUMP FOR HOT WATER SYSTEM \$ INSULATE ALL PIPES (MIN. R-3), SEE SCHEMATIC ON ME-1.
- 10. GAS FIREPLACE(S) SHALL BE A.G.A. RATED & INSTALLED
- 11. INSULATE ALL INTERIOR WALLS, USE R-11 @ 2×4 WALLS &
- R-19 @ 2×6 WALLS, TYP.
- 12. ALL SHOWER HEADS TO BE MOUNTED @ 6'-6" A.F.F. 13. MAX. LENGTH OF HYAC FLEX-DUCT NOT TO EXCEED 25'-0".
- 14. PROVIDE FIRE BLOCKING @ MAX. 10'-0" O.C. HORIZ. AT ANY WALL(S) THAT EXCEED 10'-0" IN HEIGHT.

PER MANUF. SPECIFICATIONS.

15. SEE STRUCT. FOR ADDITIONAL NOTES & SCHEDULES.



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11-14-22

12-5-22 ADU SIZE REDUCTION



Patio

3'-0" 5'-0" 5'-0"

6" STEP

6080 FR.SL.

16'0" × 14'4"

SNACK BAR

KILCh.

17'-Ø"

W/ 6030 F. ABV. S.H. W/ 3030 F.

3070 \ FR.DR.

PANTRY

A-5

30'-0" CONC.

3060 TEMP. S.H. w/ 3030 F.

1'-10"

REF.

A.D.U. LIVABLE AREA APPROX. 720 SQ.FT

\_\_\_\_<u>ROOF LINE ABOVE, TYP.</u>\_\_\_

6080 FR.DR.

w/ 6030 F. ABV.

/1'@"/X 1@'@"

STACK

W/D /

HATCHED AREA:-

FLAT CLG. @ +8'-1", TYP.

PGALW.

MIN. 22"X3Ø" ATTIC ACCESS TO HVAC

PLATFORM ABV.

2020 | TEMP.

, 2'-6" , 2'-6"

a.d.u. Plan

SCALE 1/4" = 1'-0"

12'6" × 12'9"


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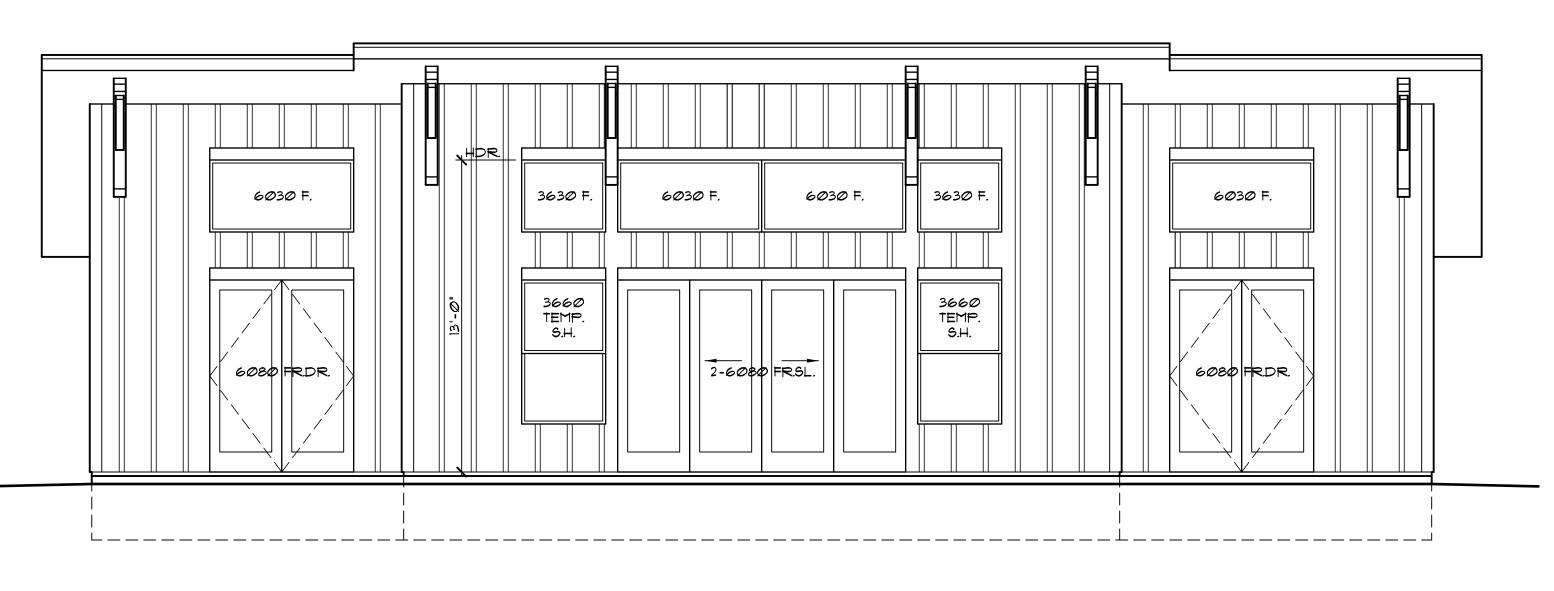
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Drawing title


FLOOR PLANS






UOLFH Granstiou SCALE 1/4" = 1'-0"

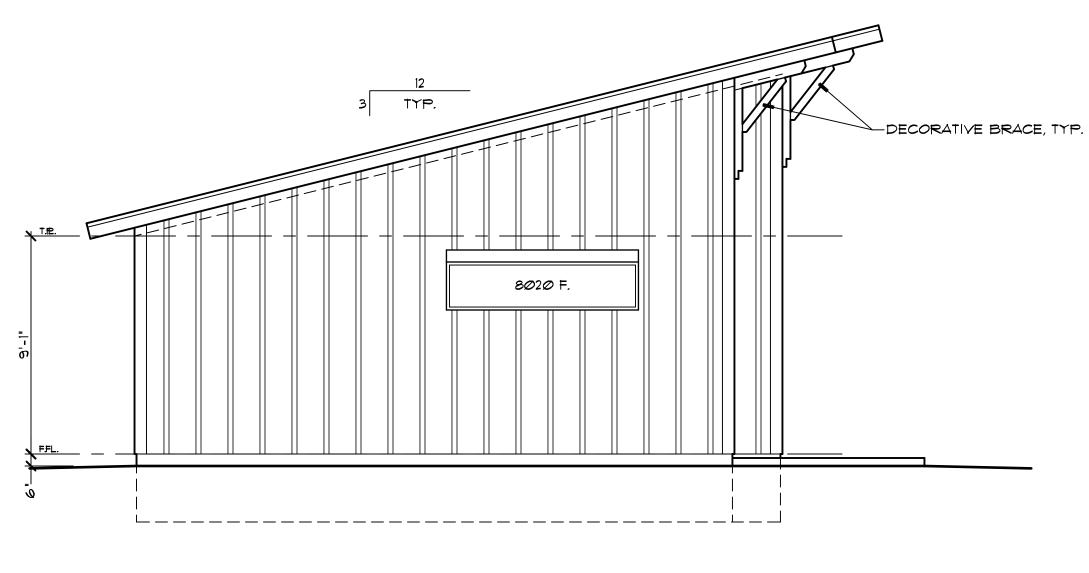east elevation SCALE 1/4" = 1'-0"

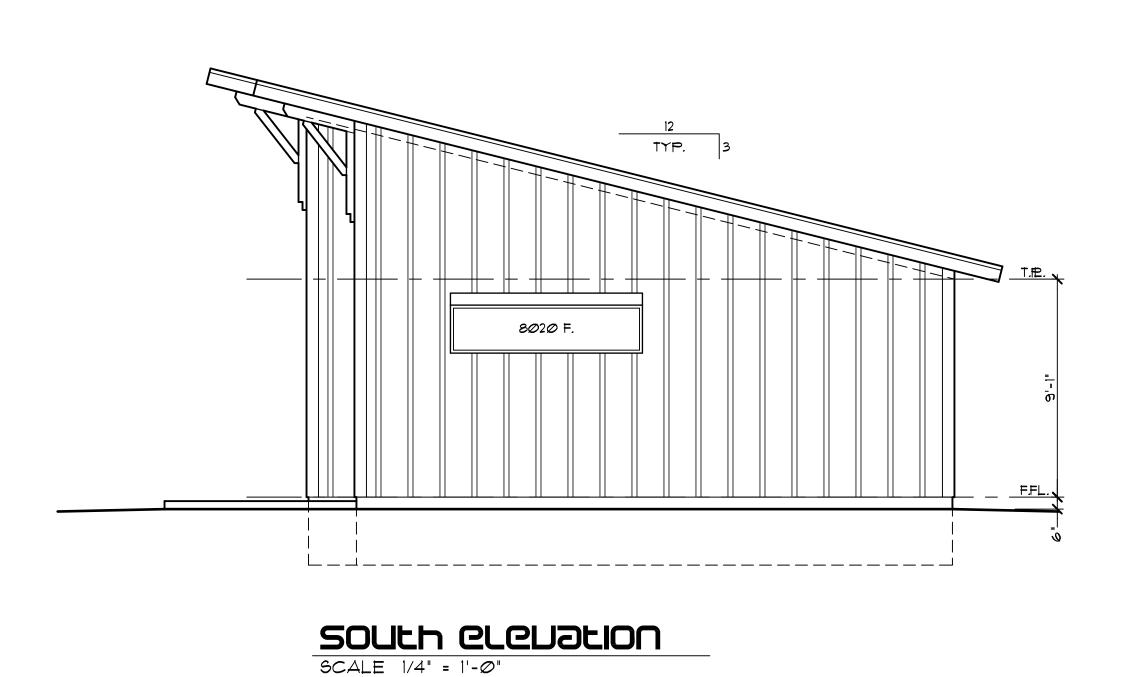

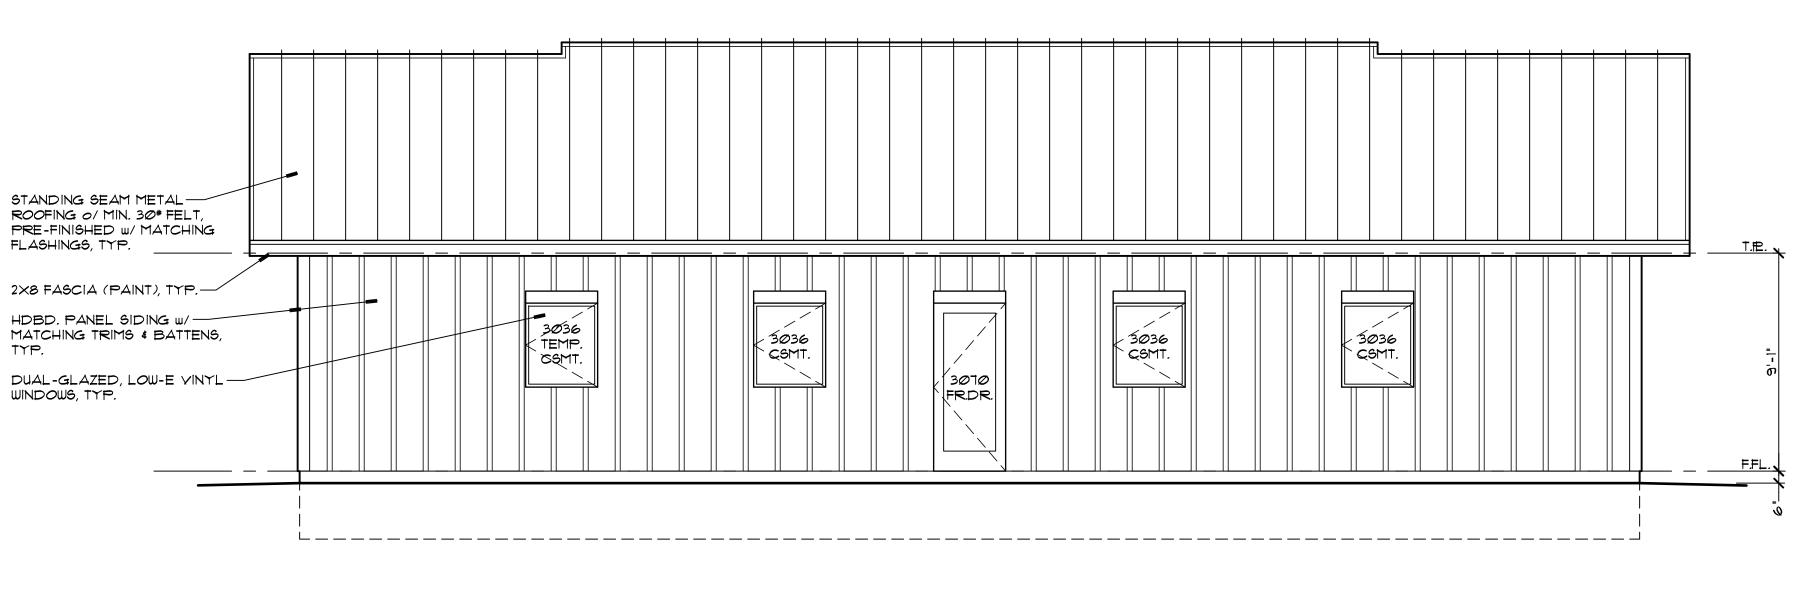


West eleuation

SCALE 1/4" = 1'-0"

architect

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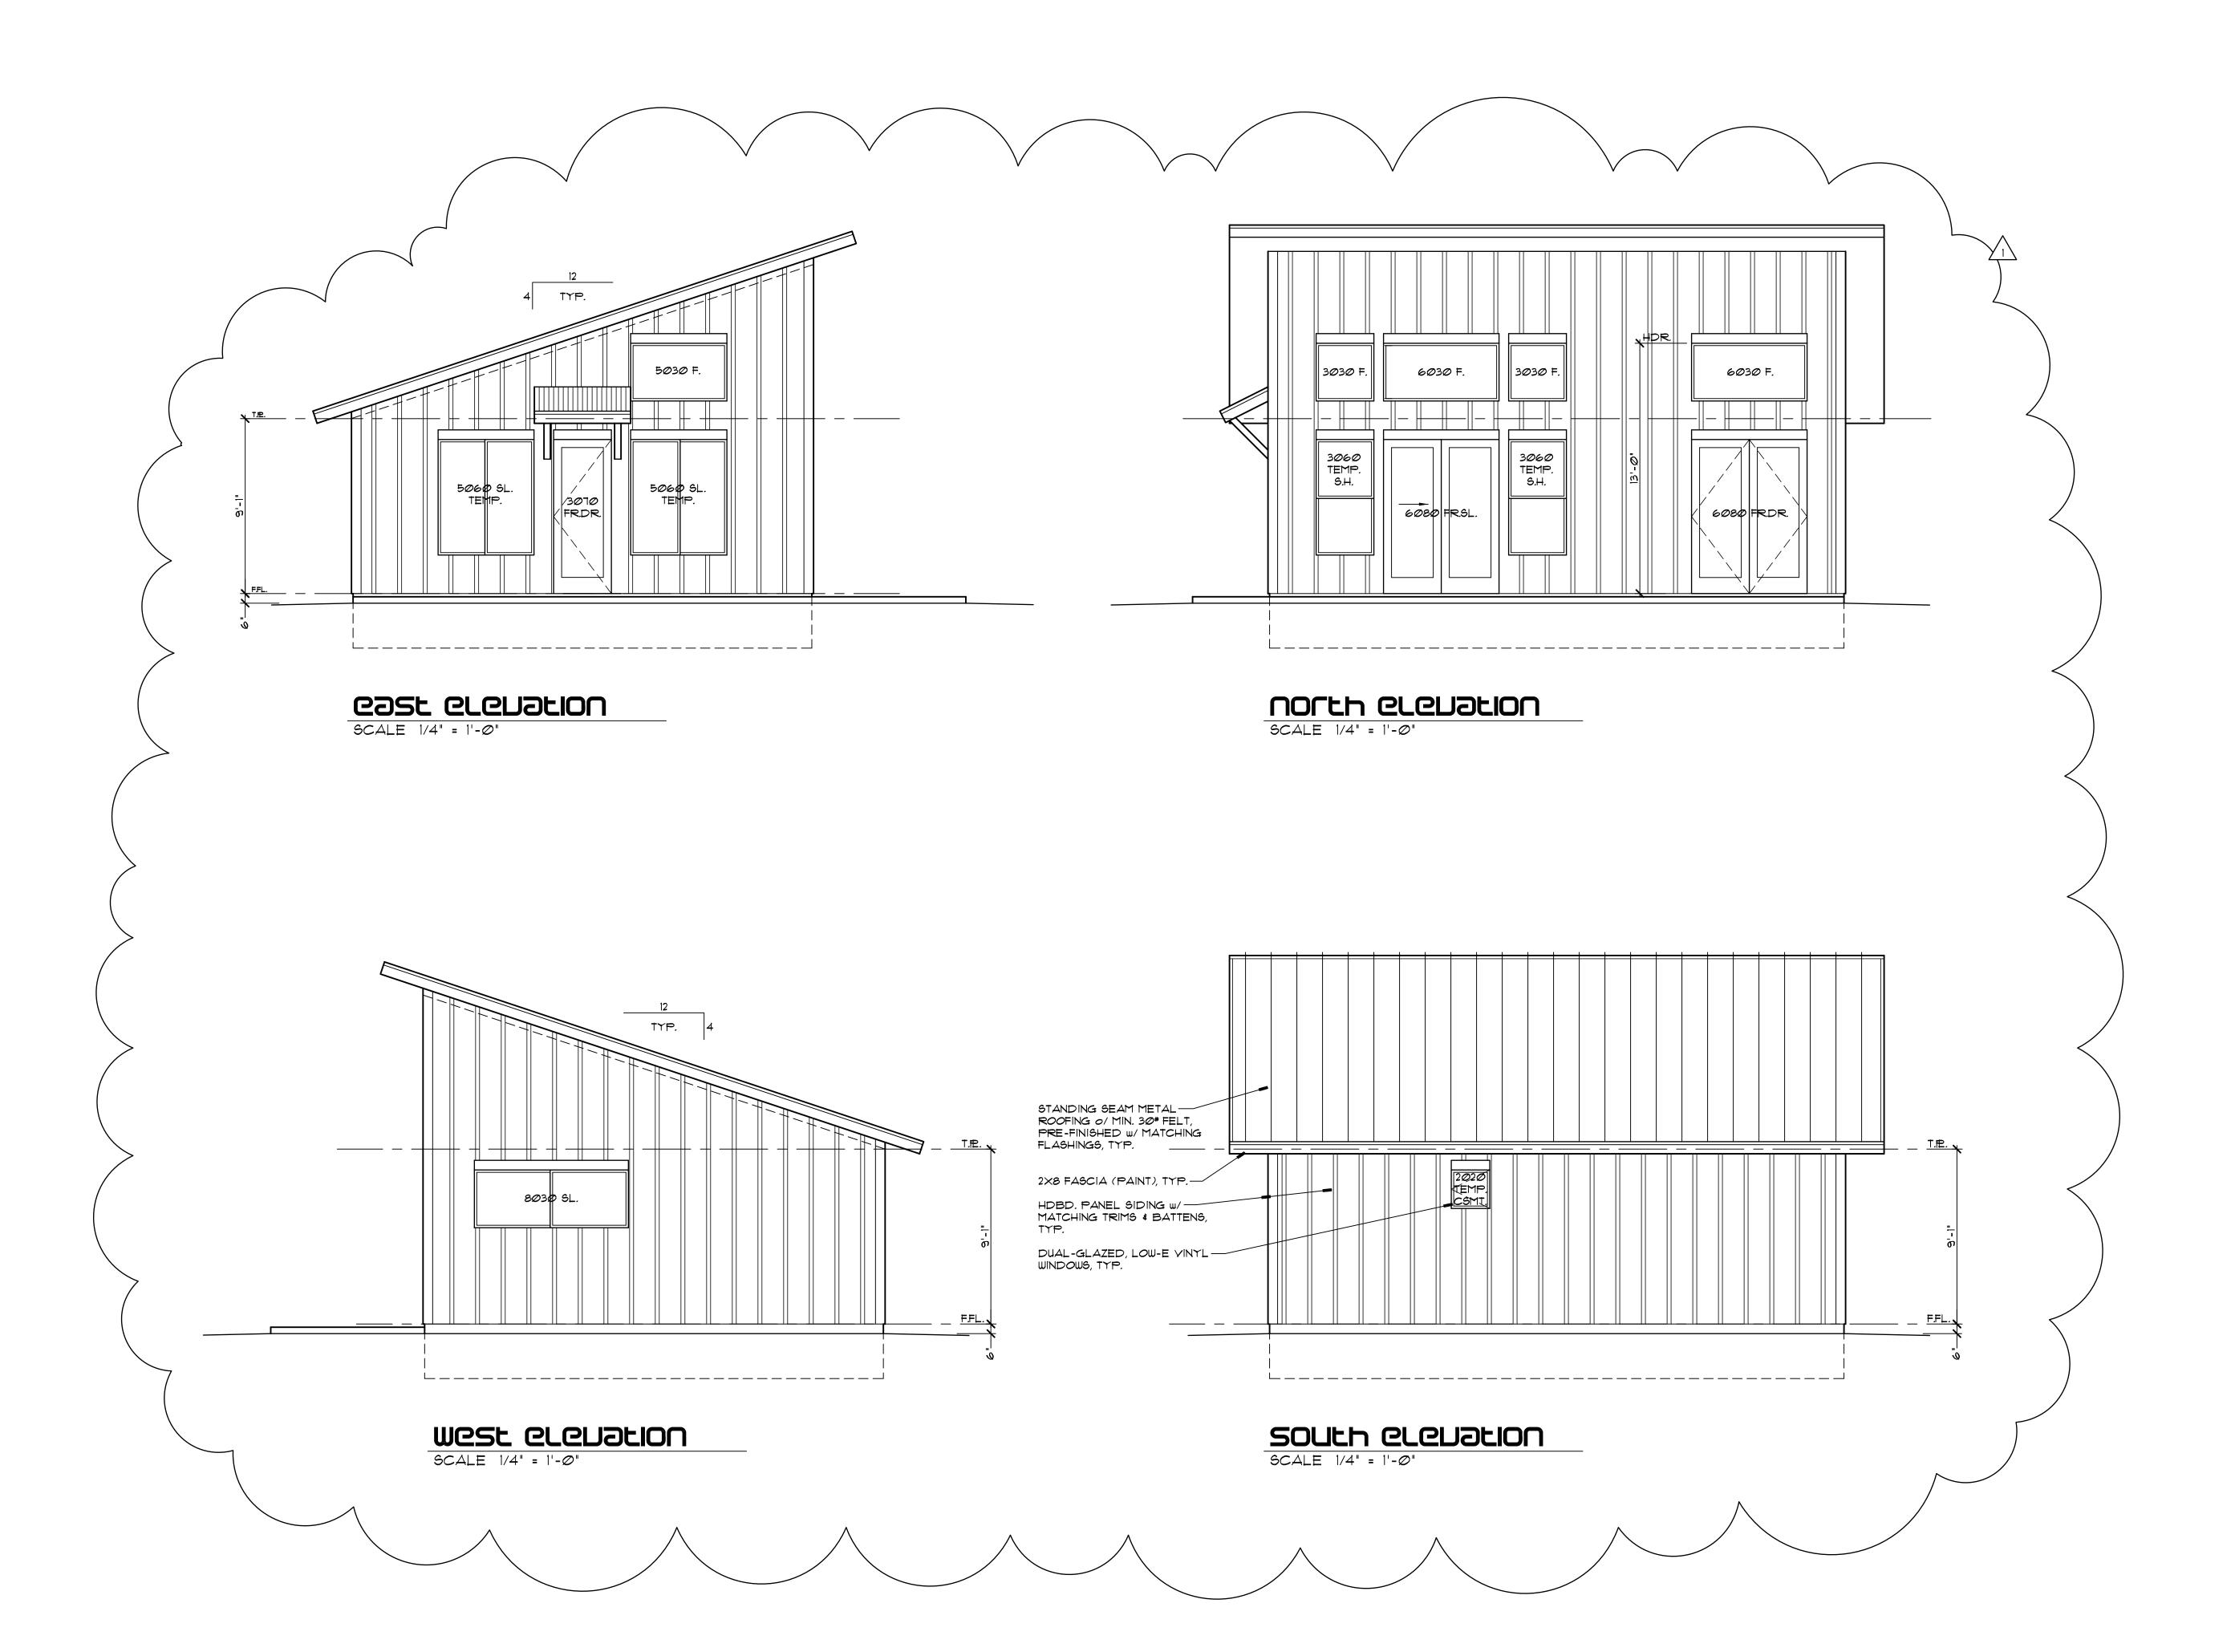


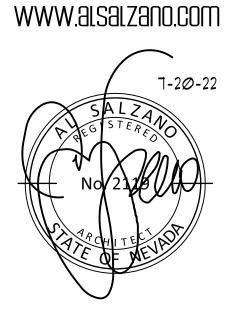6-58-55

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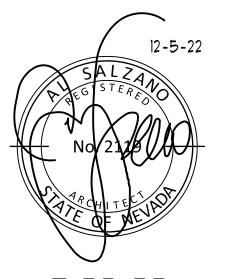
EXTERIOR ELEVATIONS MAIN HOUSE



SALZANO

alchipecp

5935 913SS VALLEY 10AD 16NO, NEVADA 89510 775.233.1984 CELL AJSALZANO @ AOL.COM WWW.ALSALZANO.COM



6-28-22

12-5-22 ADU SIZE REDUCTION

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3

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Jeremy munoz 5020 mayberry Drive

POT:

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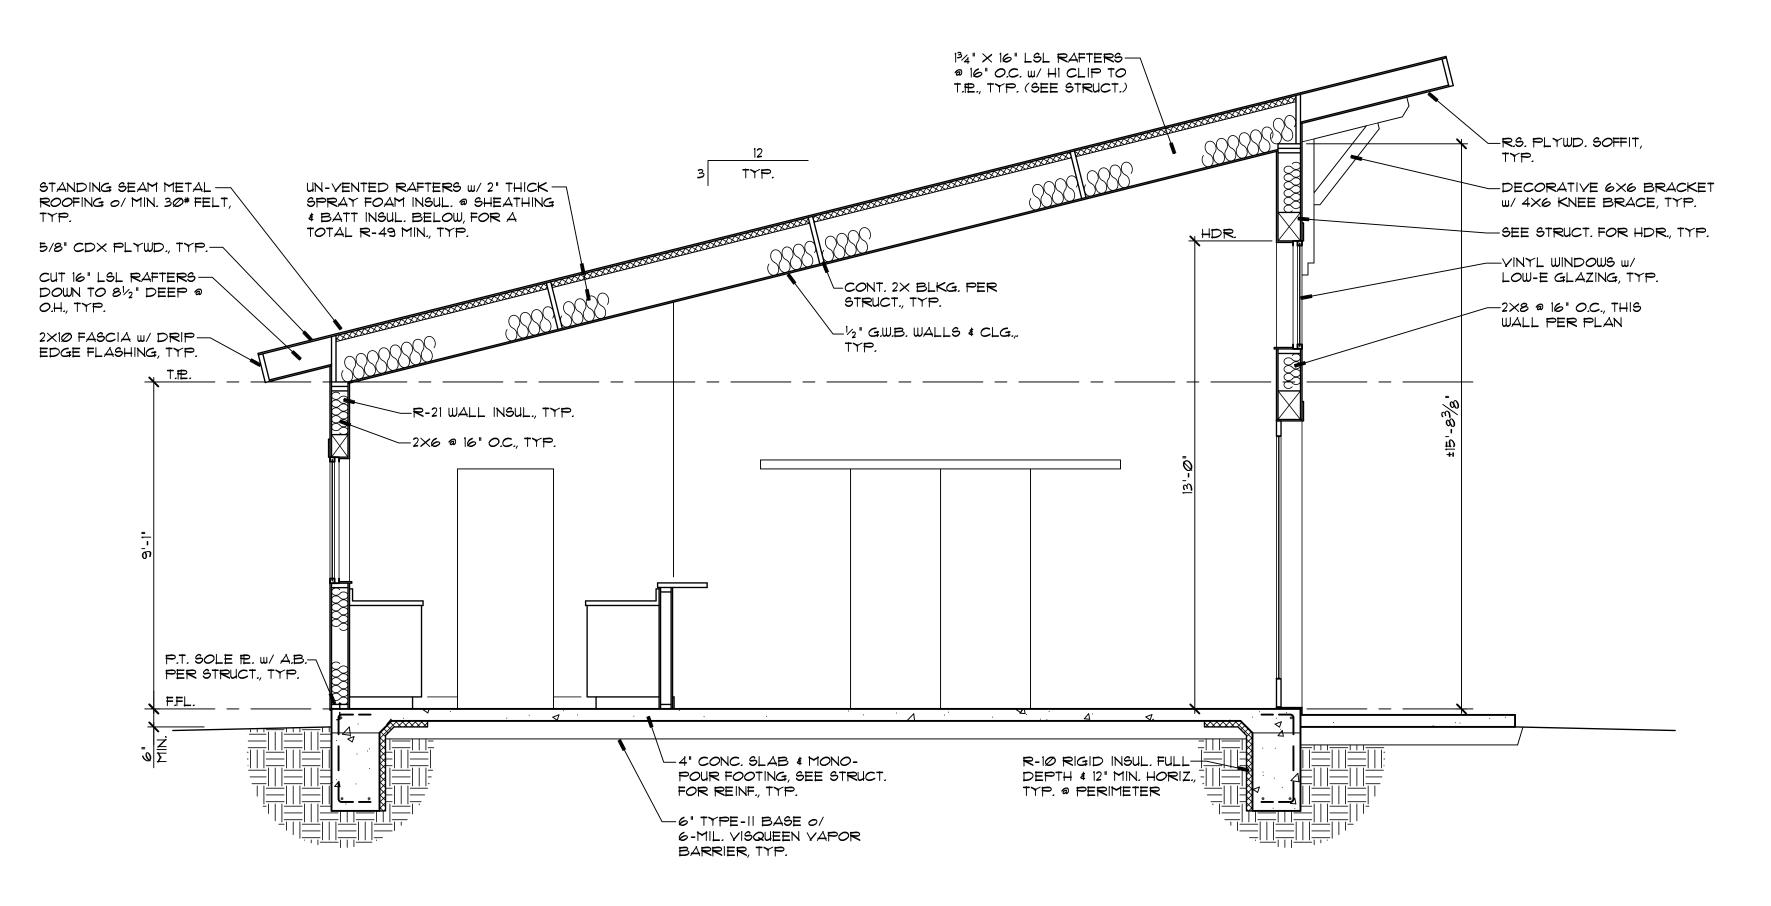
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EXTERIOR ELEVATIONS A.D.U.

approvals:


JOB NO.:

P-P



### PAILAIUD SECTIOU 'A'

SCALE 3/8" = 1'-Ø"

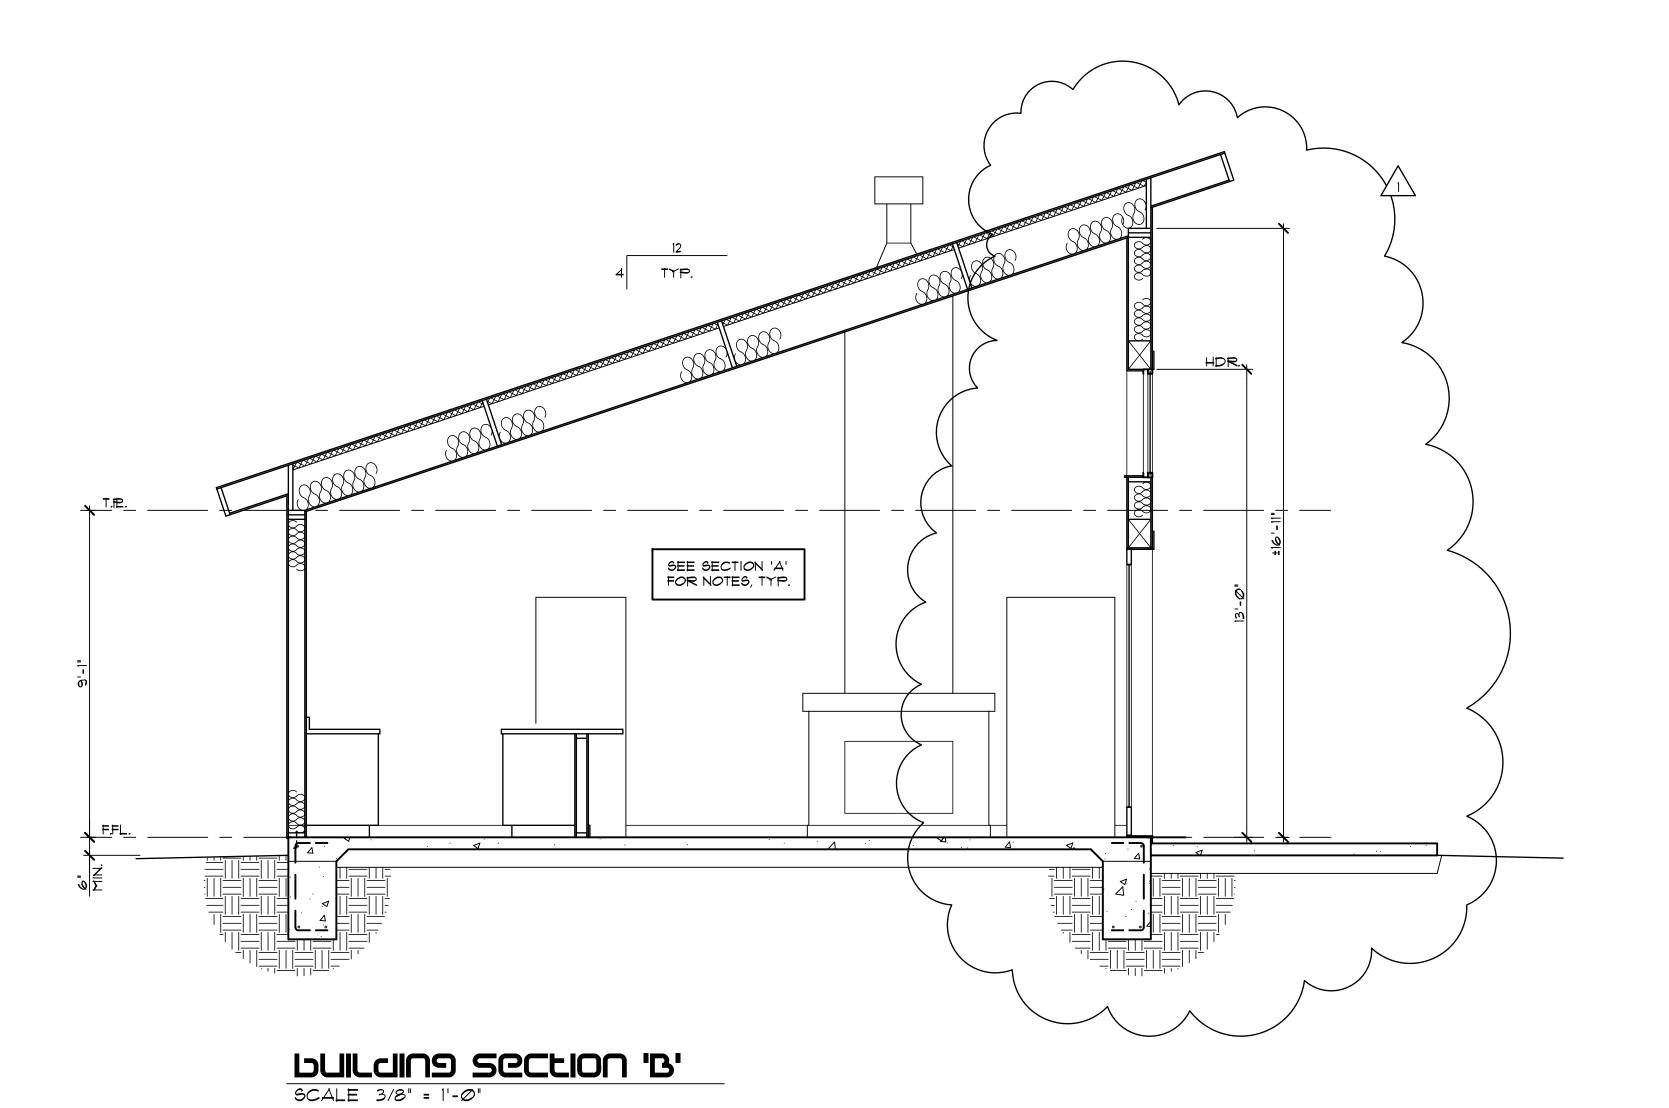

SFLZANO architect

5935 9fass valley foad

1935 91355 Valle9 1030 1900, NeVada 89510 175.299.1984 Cell 193812800 @ 301.000 193812800.000



**6-6-52** 

12-5-22 ADU SIZE REDUCTION





# CW CESICIENCE & J.C.L. REMY MUNDZ

# <u>...</u>


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Drawing title

BUILDING SECTIONS

approvals:

JOB NO.:

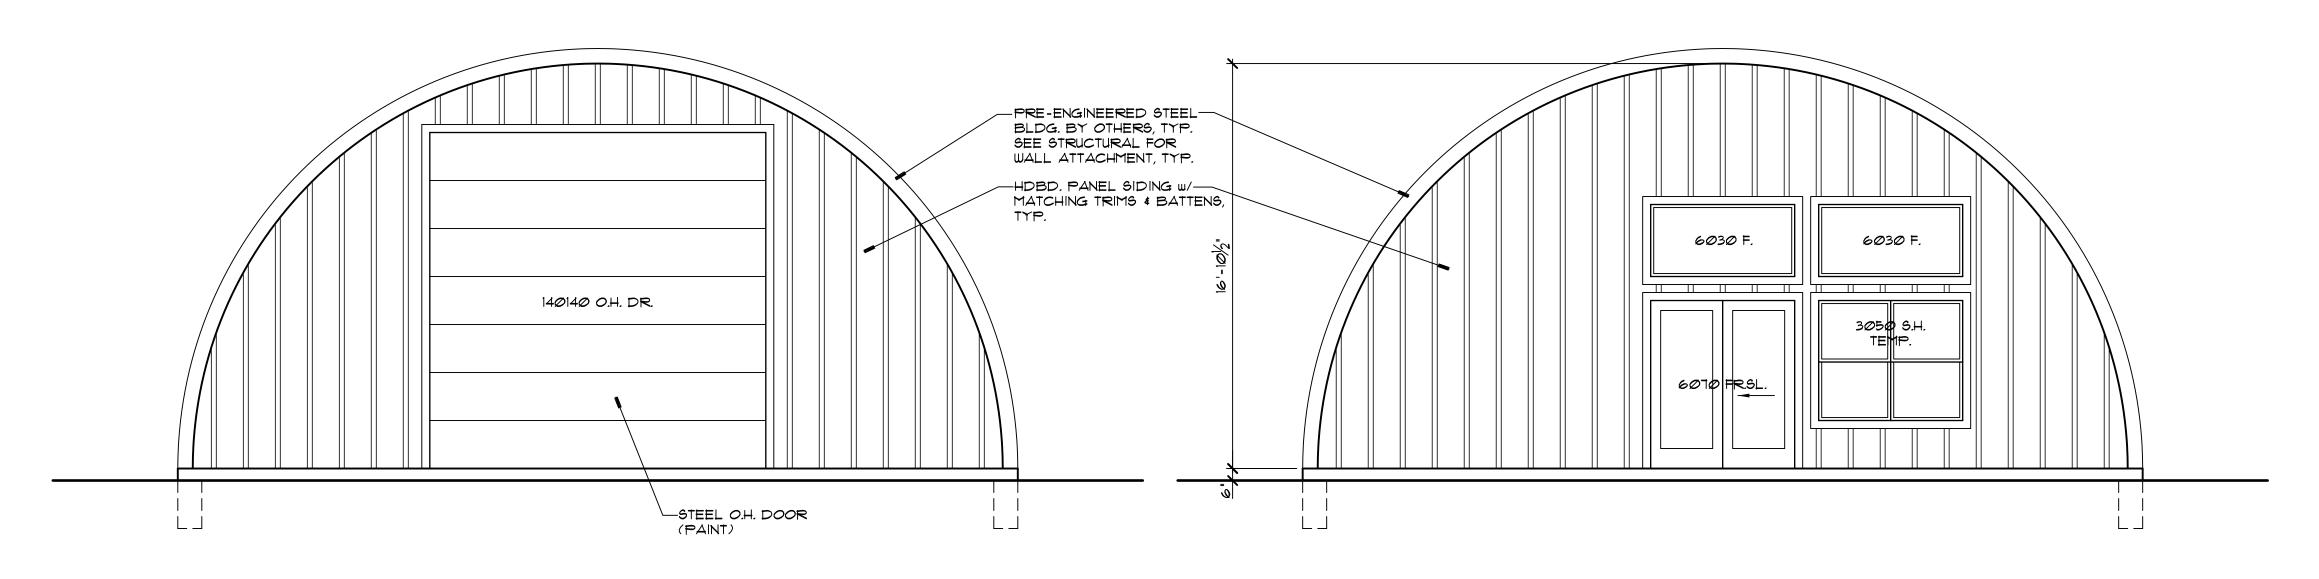

NOCHH CLCUATION

SCALE 1/4" = 1'-0"

# SOULH CLCUOLION SCALE 1/4" = 1'-0"

### WILDLOND ULPSU INFELESCE UOFGE

### GENERAL (W.U.I.) NOTES:

- 1. ALL EXTERIOR BUILDING MATERIALS MUST COMPLY W/ 2018 WILDLAND URBAN INTERFACE (W.U.I.) CODE FOR NEW CONSTRUCTION.
- 2. ALL BUILDING MATERIAL MUST BE INSTALLED PER MANUF. DETAILS & SPEC'S. SEE EXTERIOR ELEVATIONS & BUILDING SECTIONS FOR LOCATION & DETAILS OF BUILDING MATERIALS LISTED BELOW.
- 3. PROPERTY IS DESIGNATED AS 'MODERATE FIRE HAZARD'. W.U.I. TABLE 503.1 W/ DEFENSIBLE SPACE & NON-CONFORMING WATER SUPPLY = IR2 (CLASS 2) CONSTRUCTION REQ'D.

### PROPOSED (W.U.I.) BUILDING STANDARDS:

### ROOFING:

- ROOFING MATERIAL:

  ASPHALT SHINGLES, MIN. CLASS 'B' FIRE-RESISTIVE. INSTALL PER

  MANUF. & CHAPTER 9 OF THE I.R.C.
- ROOF COVERING:
  NO SPACE BETWEEN ROOF COVERING & ROOF DECKING.

### ROOF VALLEY

MIN. 0.019" NO. 26 G.A. GALV. SHEET METAL INSTALLED OVER NOT LESS THAN ONE (1) LAYER OF MIN. 72\* MINERAL-SURFACED NONPERFORATED CAP SHEET, MIN. 36" WIDE RUNNING THE FULL VALLEY LENGTH.

### ROOF GUTTERS:

- MUST BE NON-COMBUSTIBLE MATERIAL & PROVIDED w/ THE MEANS TO PREVENT THE ACCUMULATION OF LEAVES & DEBRIS IN THE GUTTER.
- VENTS:

  LOWER EYEBROW VENTS SHALL BE FIRE-RATED, O'HAGIN MFG. 'FIRE &

  ICE' LINE OR EQUAL, INSTALL PER MANUF. SOFFIT VENTS SHALL BE

  'VULCAN INDUSTRIES' OR EQUAL.

### EXTERIOR COVERINGS:

EXTERIOR WALL MATERIAL:

CEMENTITIOUS PANEL SIDING & BATTENS, 'JAMES HARDIE' OR EQUAL 
APPROVED NON-COMBUSTIBLE MATERIAL.

### EXTENT OF COVERING:

EXTERIOR WALL COVERINGS SHALL EXTEND FROM THE TOP OF THE FOUNDATION TO THE ROOF, & TERMINATE AT 2" NOM. SOLID WD. BLOCKING BETWEEN RAFTERS @ ALL ROOF OVERHANGS.

### EAVE PROTECTION

EAVES & SOFFITS SHALL BE PROTECTED ON EXPOSED UNDERSIDE BY IGNITION-RESISTANT MATERIALS - CEMENTITIOUS SOFFIT BOARDS, 'JAMES HARDIE' OR EQUAL - APPROVED NON-COMBUSTIBLE MATERIAL.

### EXTERIOR WINDOWS & DOORS:


EXTERIOR WINDOWS & GLAZED DOOR ASSEMBLIES:
EXTERIOR WINDOWS & GLAZED DOOR ASSEMBLIES SHALL BE CONST. OF
MULTI-PANE GLAZING OR TEMPERED GLASS.

### EXTERIOR DOORS:

EITHER EXTERIOR SURFACE OR CLADDING OF NON-COMBUSTIBLE OR IGNITION-RESISTANT MATERIAL, OR CONSTRUCTED OF SOLID CORE WD. W/STILES & RAILS OF NOT LESS THAN 13/8" THICKNESS & RAISED PANELS SHALL BE NOT LESS THAN 11/4" THICK, EXCEPT FOR THE PERIMETER THAT MAY TAPER TO A TONGUE NOT LESS THAN 3/8" THICK.

### DEFENSIBLE SPACE:

- 1. PRIOR TO BUILDING PERMIT FINAL APPROVAL THE PROPERTY SHALL BE IN COMPLIANCE W/ THE VEGETATION CLEARANCE REQUIREMENTS PRESCRIBED IN W.I.C. SECTION 603 & 604 "DEFENSIBLE SPACE."
- 2. THE ENFORCEMENT OF DEFENSIBLE SPACE & INSPECTION SHALL BE PERFORMED BY THE LOCAL JURISDICTION HAVING AUTHORITY.

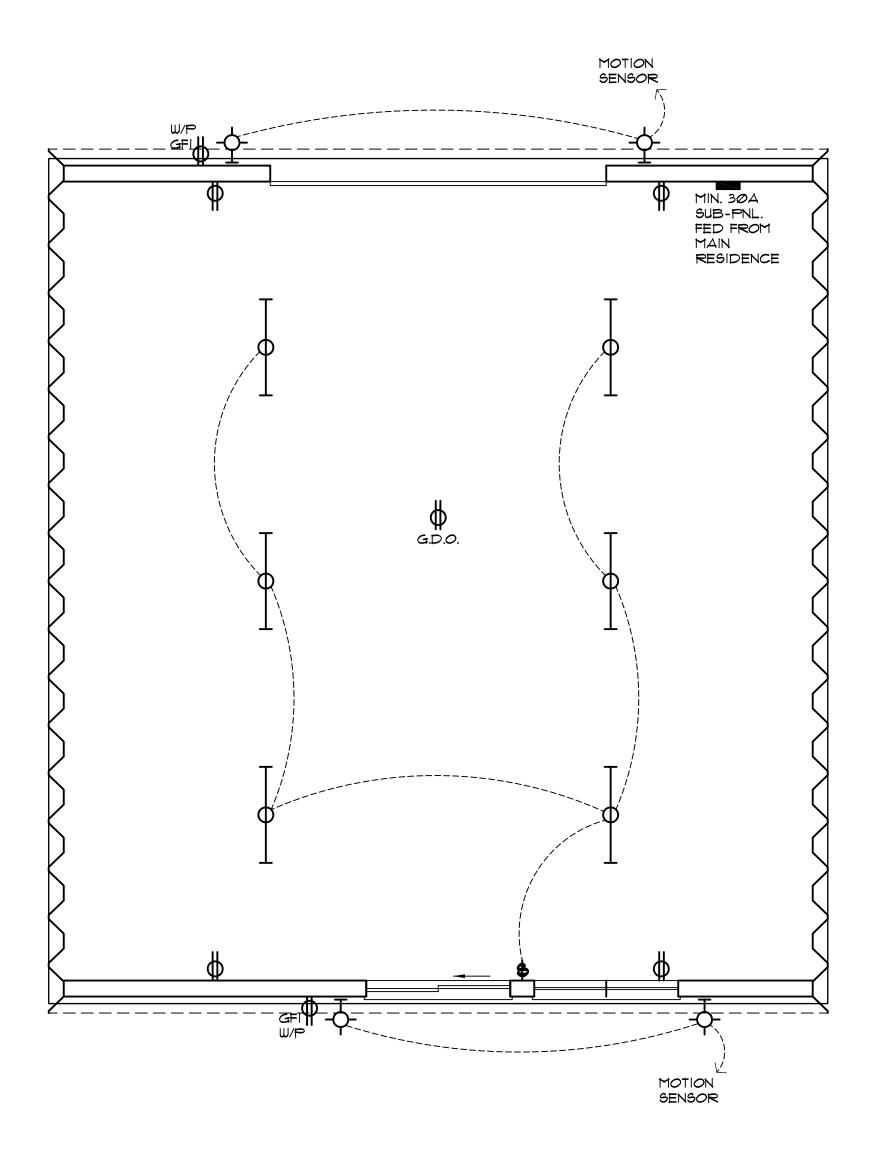





alchipecp

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**8-28-22** 

9-8-22 NEW SHEET

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3

10.6 & 3.d.u.

Jeremy Munoz 5020 Mayberry Drive

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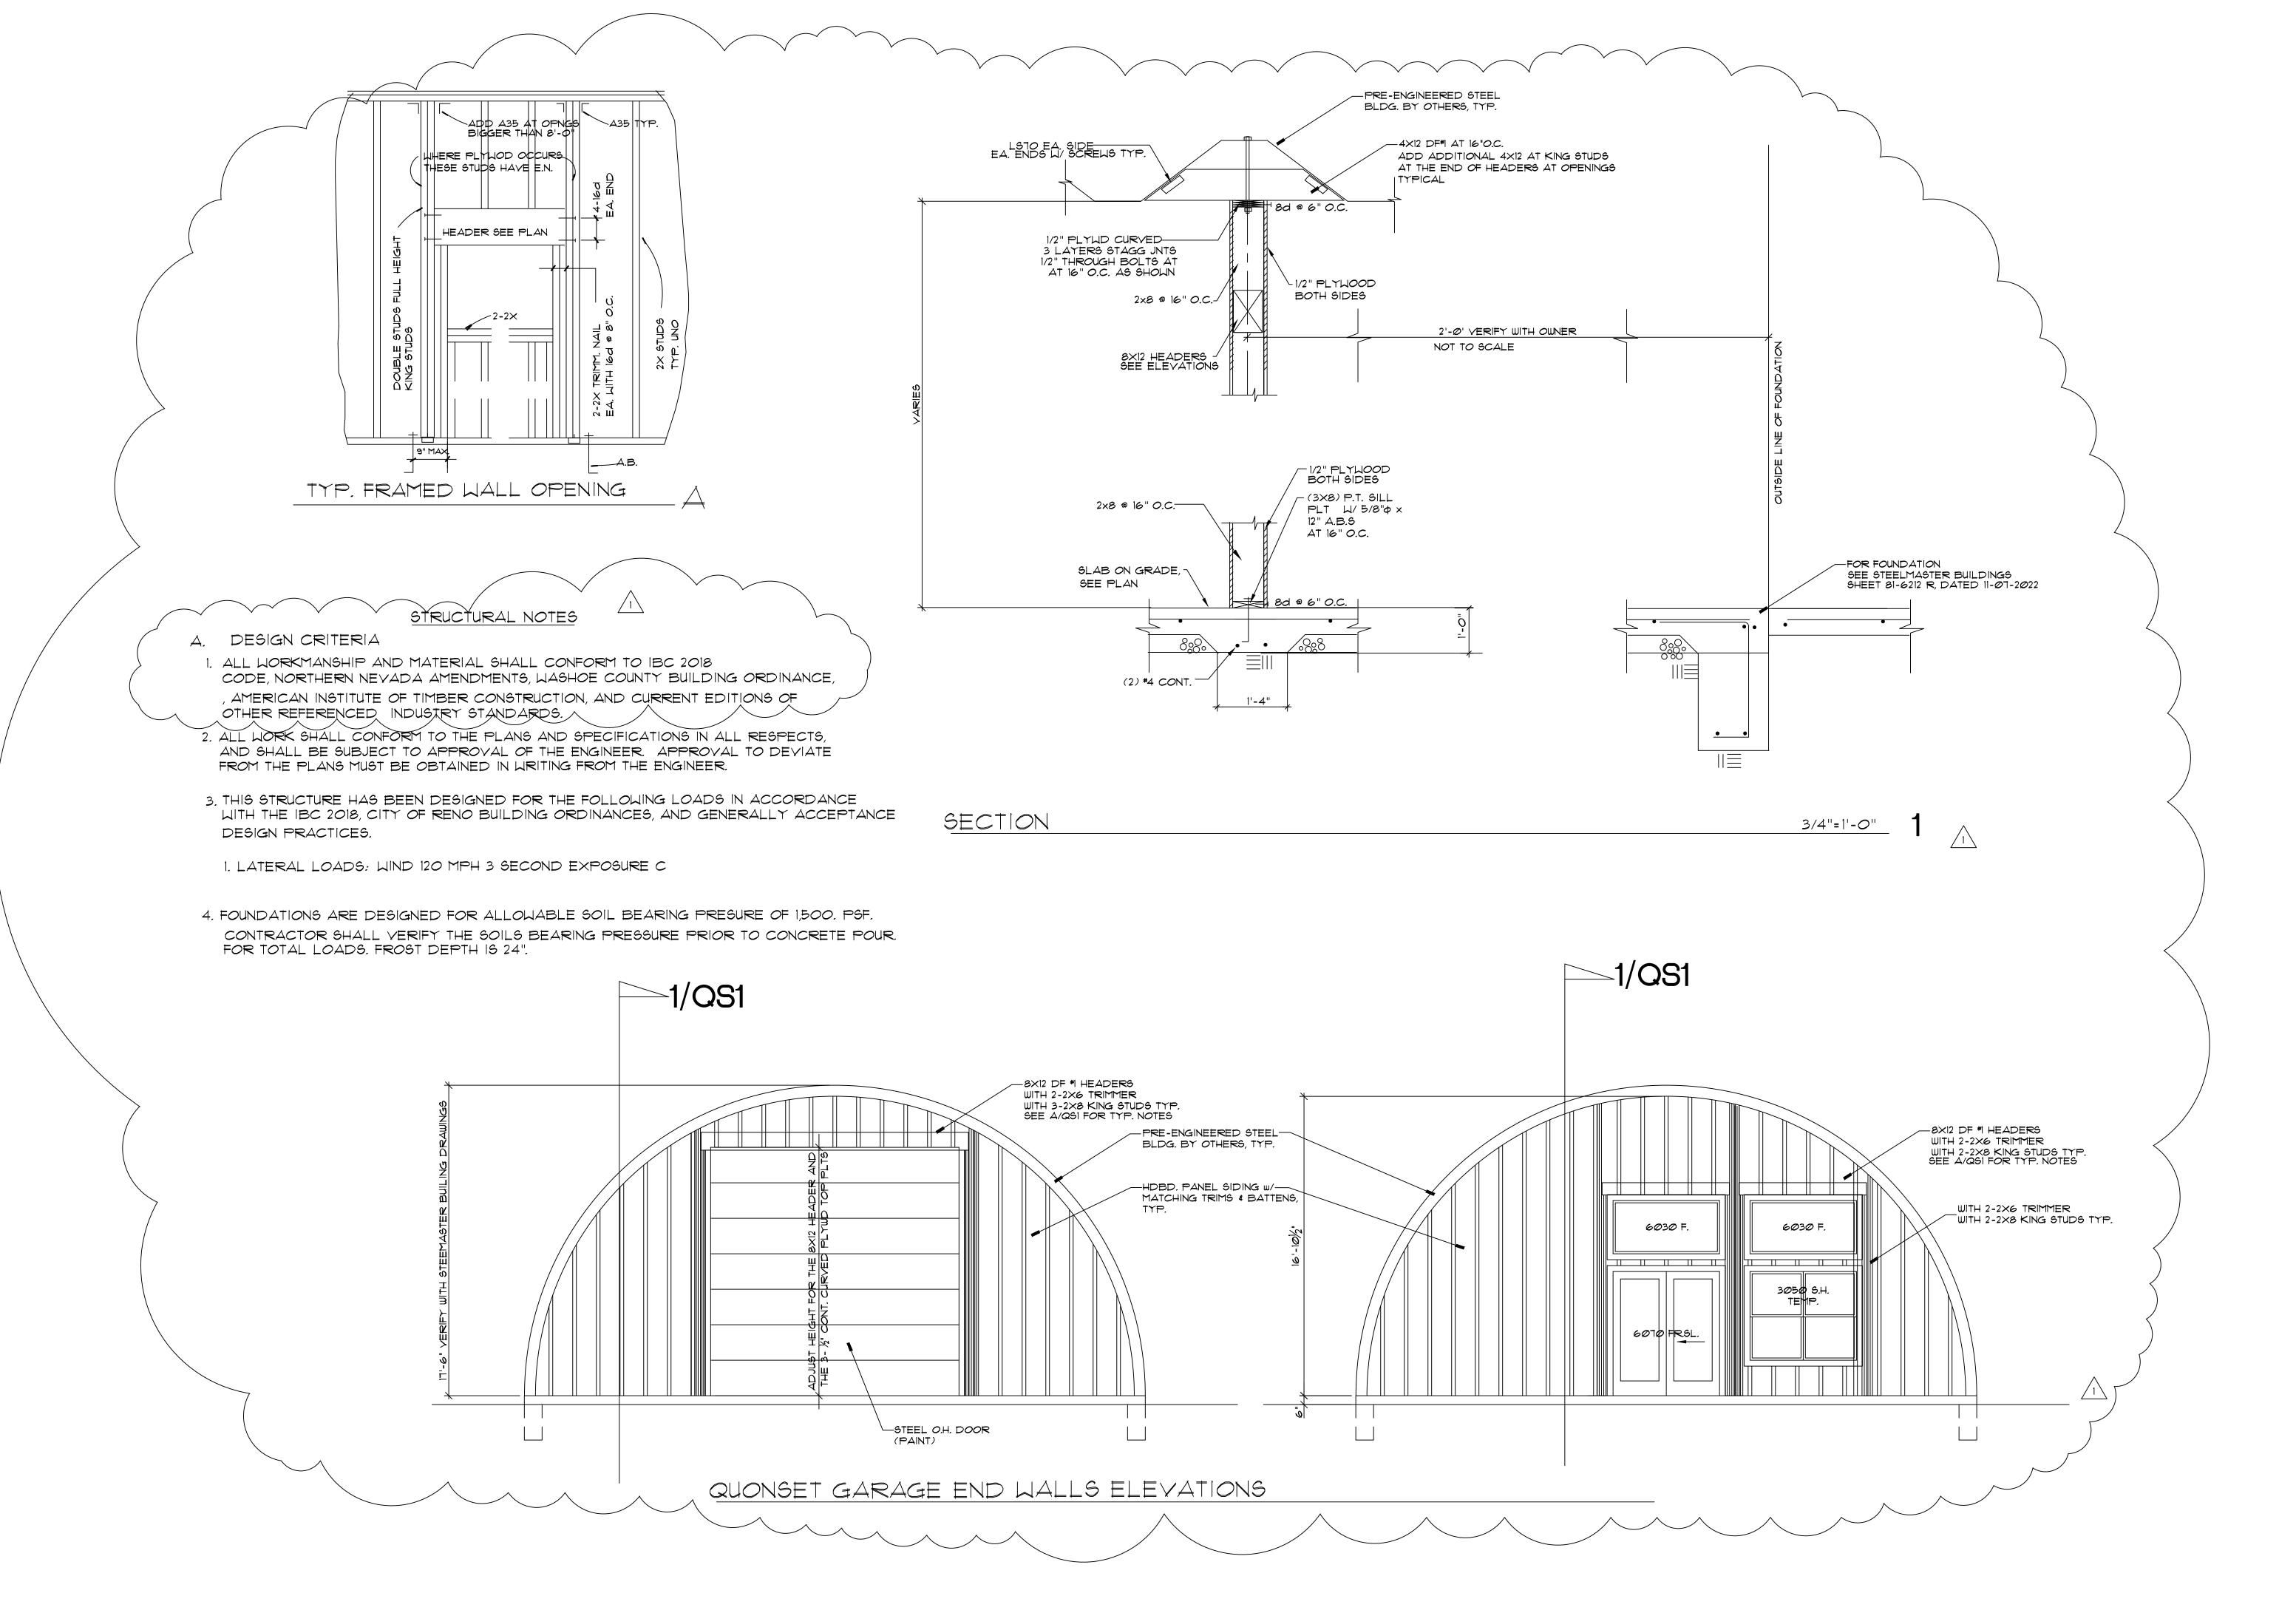
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Drawing title:

DETACHED GARAGE ELEV. & ELEC.

JOB NO.

**A-6** 





6 - 14 - 2022



PLAN CHECK 8-24-2022

 $\approx$ 

new residence jeremy munoz 5020 mayberry Drive reno, nevana


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Drawing title:

DETACHED GARAGE END WALLS







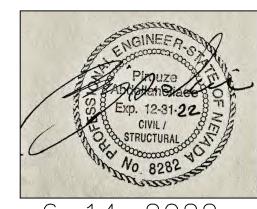

PLAN CHECK 8-2022

 $\approx$ 

 $\bigcirc$ Jeremy munoz Jeremy munoz 5020 mayberry C Feno, nevada

POF

Drawing title:

STRUCTURAL NOTES

approvals:

MUNICIPALITY APPROVAL

STRUCTURAL NOTES

### DESIGN CRITERIA

- ALL WORKMANSHIP AND MATERIAL SHALL CONFORM TO IBC 2018 CODE, AND 2018 NORTHERN NEVADA AMENDMENTS, , WASHOE COUNTY BUILDING ORDINANCE, AMERICAN CONCRETE INSTITUTE , AMERICAN INSTITUTE OF TIMBER CONSTRUCTION, AND CURRENT EDITIONS OF OTHER REFERENCED INDUSTRY STANDARDS.
- 2. ALL WORK SHALL CONFORM TO THE PLANS AND SPECIFICATIONS IN ALL RESPECTS AND SHALL BE SUBJECT TO APPROVAL OF THE ENGINEER. APPROVAL TO DEVIATE FROM THE PLANS MUST BE OBTAINED IN WRITING FROM THE ENGINEER.
- 3. THIS STRUCTURE HAS BEEN DESIGNED FOR THE FOLLOWING LOADS IN ACCORDANCE WITH THE IBC 2018, CITY OF RENO BUILDING ORDINANCES, AND GENERALLY ACCEPTANCE DESIGN PRACTICES
- 1. LIVE LOAD =LOADS: TOP CHORD LL, ROOF SNOW = 21 PSF 2. FLOOR LIVE LOAD = 40PSF
- 3. LATERAL LOADS: WIND 120 MPH 3 SECOND EXPOSURE C, SEISMIC CATEGORY D
- 4. FOUNDATIONS ARE DESIGNED FOR ALLOWABLE SOIL BEARING PRESURE OF 1,500. PSF. CONTRACTOR SHALL VERIFY THE SOILS BEARING PRESSURE PRIOR TO CONCRETE POUR. FOR TOTAL LOADS. FROST DEPTH IS 24".

### B. FOUNDATIONS

- I. THE CONTRACTOR SHALL FIELD VISIT THE JOB SITE AND MAKE INVESTIGATINS AS DEEMED NECESSARY TO DETERMINE SOIL CONDITIONS THAT MAY AFFECT HIS WORK.
- 2. BEFORE COMMENCING ANY EARTHWORK, THE CONTRACTOR SHALL YERIFY LOCATIONS OF ALL UNDERGROUND UTILITIES OR STRUCTURES AND SHALL NOT PERFORM ANY WORK THAT WILL DAMAGE OR INTERFERE WITH THE SERVICE OF SAME.
- 3. SITE PREPARATION, BACKFILL, SELECT FILL, ETC., SHALL BE AS RECOMMENDED BY THE SOILS ENGINEER
- 4. FOOTING EXCAVATIONS SHALL BE NEAT AND TRUE, WITH ALL LOOSE MATERIAL REMOVED BEFORE FOOTING CONCRETE IS PLACED. EXCAVATIONS SHALL BE PROTECTED FROM FREEZING.
- 5. ALL INTERIOR SLABS-ON-GRADE SHALL BE CONSTRUCTED AS FOLLOWS, PLACE 6" OF TYPE 2 CLASS B AGGREGATE BASE, COMPACT TO 95% COMPACTION
- 6. ALL FOUNDATIONS SHALL BE PLACED ON FIRM UNDISTURBED EARTH. HOLES DUE TO REMOVAL OF LARGE ROCKS OR OVER-EXCAVATION SHALL BE FILLED WITH CONCRETE.
- J. UNLESS SHOWN OTHERWISE, FOOTINGS SHALL BE PLACED A MINIMUM OF 24 INCHES BELOW THE FINISHED EXTERIOR GRADE.
- 8. ALL LOOSE SOIL AND FILL, INCLUDING BACKFILL BEHIND WALLS SHALL BE PLACED IN 8" LIFTS AND COMPACTED TO AT LEAST 95% OF MAXIMUM DENSITY.

### REINFORCED CONCRETE:

- 1. ALL CONCRETE WORK AND MATERIALS SHALL CONFORM TO ACI 318.. AND
- 2. CAST-IN-PLACE CONCRETE SHALL HAVE THE FOLLOWING MINIMUM COMPRESSIVE STRENGTHS IN 28 DAYS

FOOTINGS, WALLS, GRADE BEAMS 3000 PSI SLABS-ON-GRADE 3500 PSI

CEMENT SHALL BE IN ACCORDANCE WITH ASTM 150 TYPE II UNLESS NOTED OTHERWISE, DESIGN IS BASED ON FIC LESS THAN OR EQUAL TO 2500 PSI, THEREFORE, SPECIAL INSPECTION IS NOT REQUIRED

THE MAXIMUM SLUMP SHALL BE. SLABS OTHER CONCRETE

- 3. REINFORCING STEEL SHALL BE ASTM A 615 GRADE 60.
- 4. ALL HORIZONTAL BARS SHALL BE BENT AT CORNERS WITH A 24" EXTENSION, OR HAVE MATCHING CORNER BARS WITH 24" LEGS. ALSO REFER TO SHEET SO.2.
- 5. PROVIDE LAP SPLICES AS FOLLOWS: #3 AND #4 BARS LAP 24" MINIMUM, #5 BARS LAP 30" MINIMUM.
- 6. ALL REINFORCEMENT SHALL BE SECURELY TIED IN PLACE BEFORE PLACING CONCRETE.

1. SAWN LUMBER SHALL BE DOUGLAS FIR - AND SHALL HAVE THE FOLLOWING MINIMUM GRADES (SEE THIS SHEET FOR TYPICAL NAILING REQUIREMENTS).

DESCRIPTION GRADE  $\mathrel{\reflet}$  all joists, studs & Plates TYPICAL FRAMING NO. 2 ---6X BEAMS HDRS NO. 2×12'S ROOF JOISTS DF#1. 4X BEAMS HDRS POST AND TIMBERS NO.


SOLE PLATES AND WOOD WITHIN 8" OF EARTH SHALL BE PRESSURE


TREATED DOUGLAS FIR NO. 2 LUMBER SHALL HAVE A MOISTURE CONTENT LESS THAN OR EQUAL TO


- 2. PLYWOOD SHEATHING SHALL BE APA STAMPED CD SPAN RATED PANELS, EXPOSURE I, SEE PLAN FOR THICKNESS AND NAILING.
- 3. FLOOR SHEATHING SHALL BE STURD-I-FLOOR. NAIL WITH 10D RING OR SCREW-SHANK NAILS. FLOOR SHEATHING SHALL BE GLUED TO SUPPORTS. APPLY GLUE AS RECOMMENDED BY APA AND THE MANU-FACTURER.
- 4. ALL NAILS SHALL BE COMMON NAILS, EXCEPT AS NOTED ON THE PLANS.
- 5. NAILS WHICH WILL BE EXPOSED TO WEATHER SHALL BE EITHER ZINC COATED, ALUMINUM ALLOY WIRE, OR STAINLESS STEEL
- 6. ALL ROUGH FRAMING SHALL CONFORM TO THE IBC.
- 7. FRAMING HARDWARE SHALL BE AS MANUFACTURED BY THE SIMPSON STRONG-TIE CO. OR APPROVED EQUAL AND OF TYPE AND SIZE INDICATED ON THE PLANS, INSTALLATION SHALL BE AS RECOMMENDED BY THE MANUFACTURER.
- 8. SPECIAL CARE SHALL BE GIVEN TO THE FABRICATION OF BEARING SURFACES OF COLUMNS TO ENSURE THAT MEMBERS FIT TIGHTLY AND THE INTERFACING SURFACES ARE TRUE.
- 9. BOLTS SHALL BE MACHINE BOLTS (ASTM A 307). USE WASHERS WHERE BOLT HEAD OR NUT BEARS ON WOOD. HOLES SHALL BE 1/32" LARGER IN DIAMETER.


### H. MISCELLANEOUS

- WORKING DIMENSIONS SHALL NOT BE SCALED FROM THE PLANS, SECTIONS OR DETAILS.
- 2. CONSTRUCTION OR DETAILS FOR ELEMENTS OR PORTIONS OF THE WORK NOT SPECIFICALLY SHOWN SHALL BE SIMILAR TO CONSTRUCTION OR DETAILS SHOWN.
- 3. NOTES AND DETAILS SPECIFICALLY INDICATED SHALL TAKE PRECEDENCE OVER THE STRUCTURAL NOTES.
- 4. THE CONTRACTOR SHALL CHECK AND COORDINATE WITH ELECTRICAL AND MECHANICAL CONTRACTOR FOR BLOCK OUTS, CONDUIT, PIPE SLEEVES, EMBEDDED ITEMS, ETC, TO BE EMBEDDED IN CONCRETE AS WELL AS OPENINGS IN STRUCTURE FOR MECHANICAL AND ELECTRICAL INSTALLATIONS.
- 5. THE CONTRACTOR SHALL PROVIDE AND MAINTAIN ADEQUATE ERECTION SHORING AND BRACING AS REQUIRED FOR STABILITY OF THE STRUCTURE DURING ALL PHASES OF CONSTRUCTION.

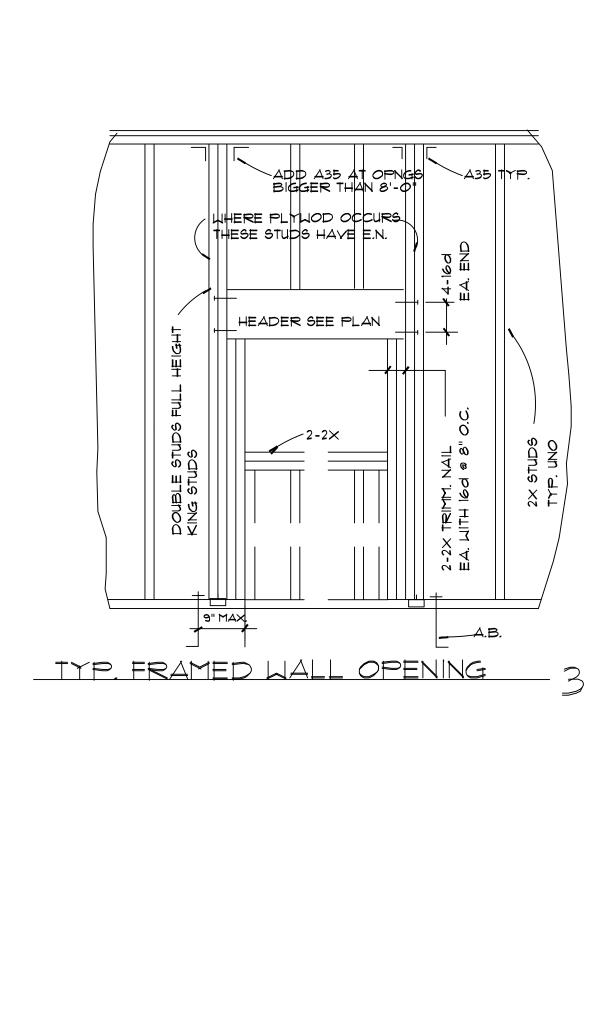

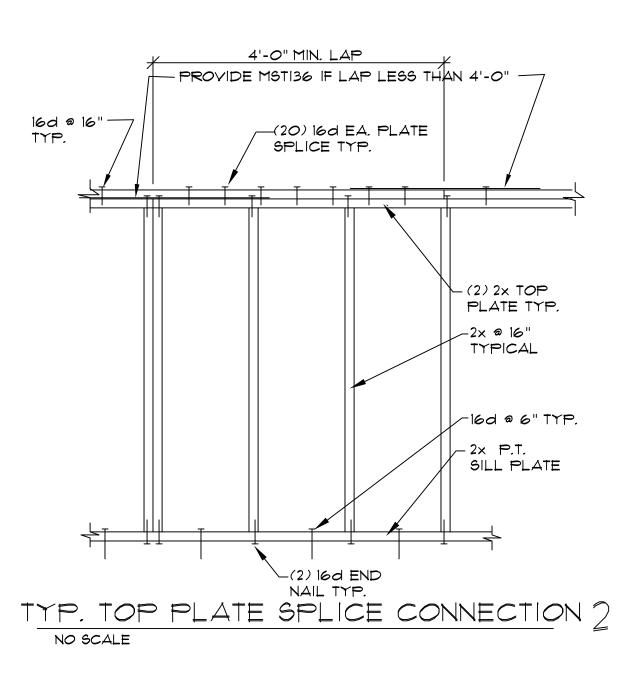


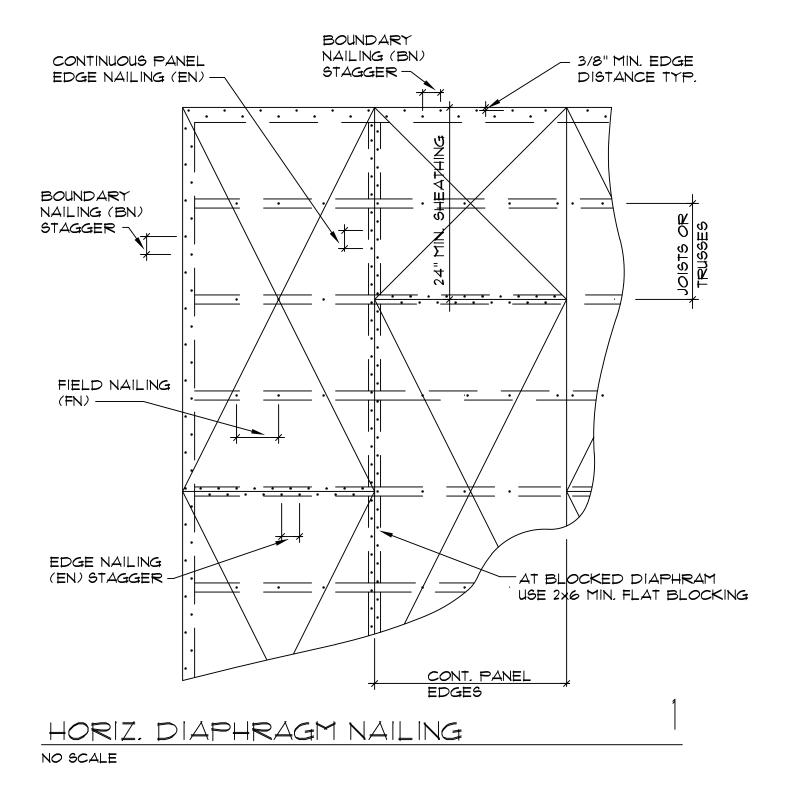


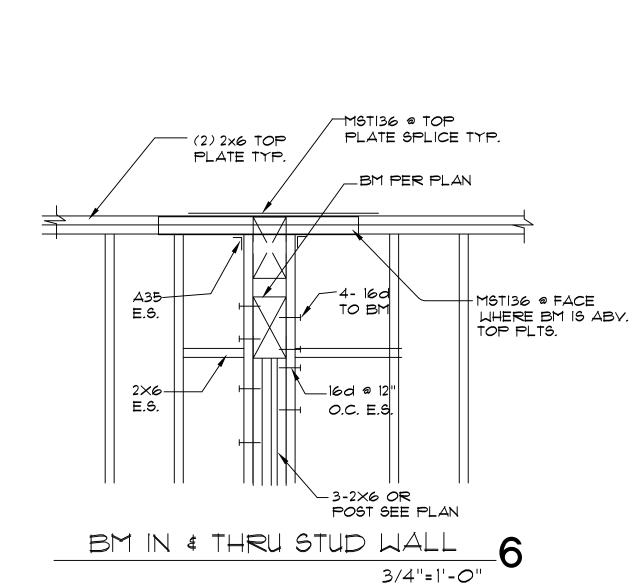



CONCRETE WALLS

NO SCALE

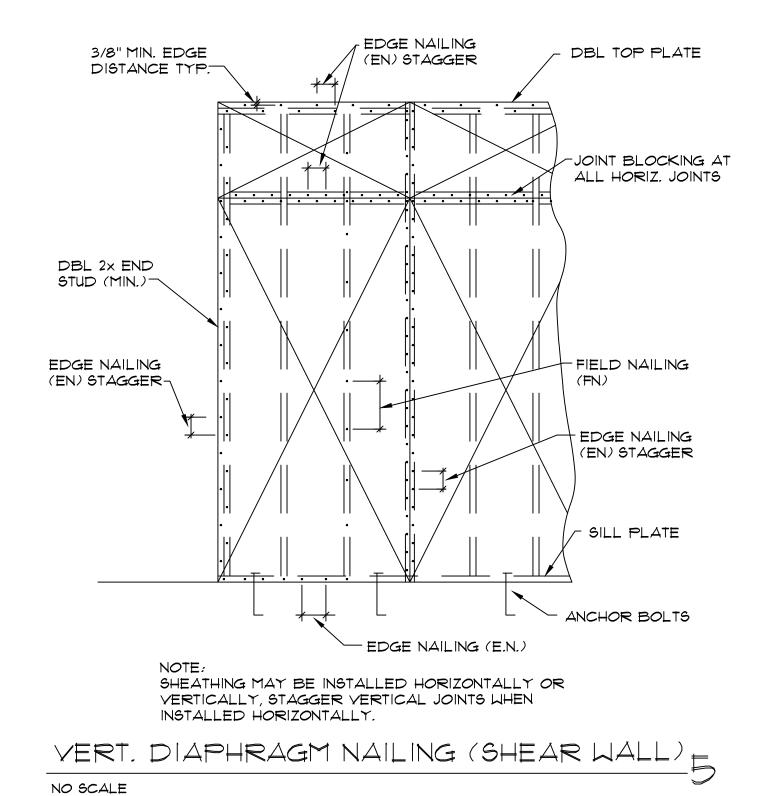

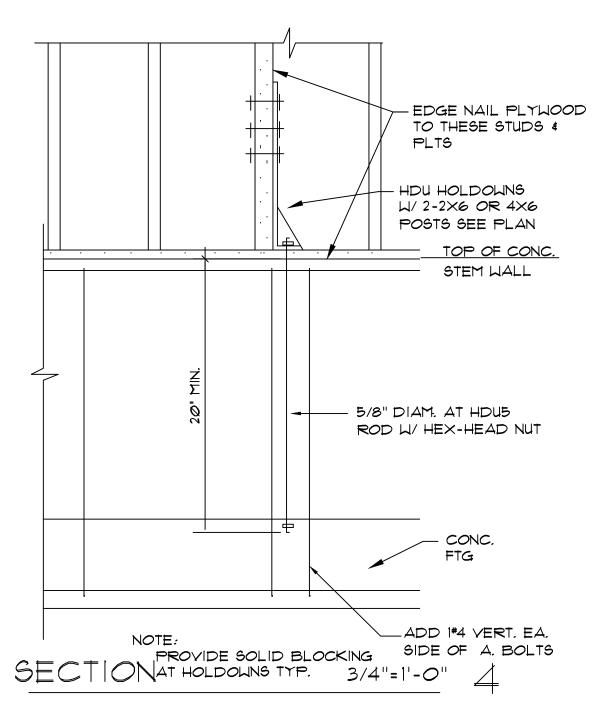

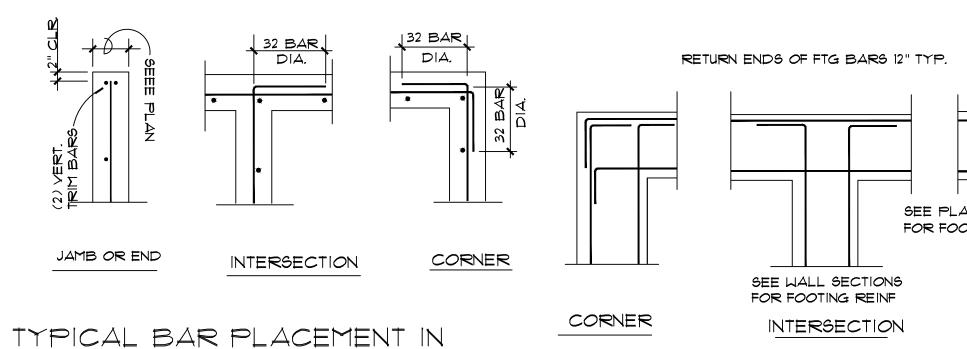

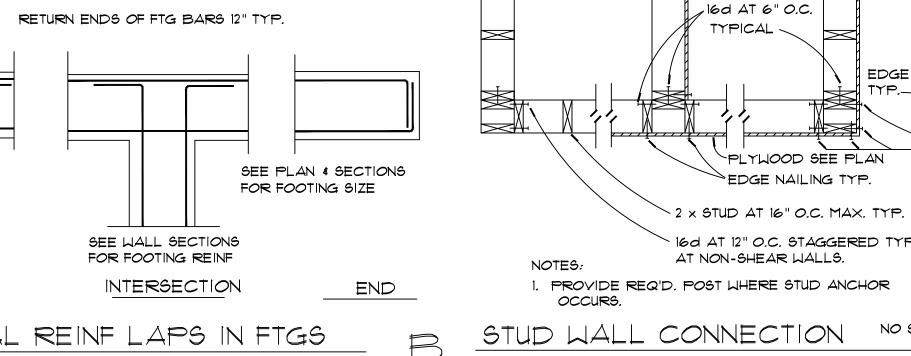

CORNER TYPICAL REINF LAPS IN FTGS NO SCALE

/16d AT 6" O.C. EDGE NAILING > 16d AT 12" O.C. STAGGERED TYP.

6 - 14 - 2022



2

 $\bigcirc$  $\approx$  $\bigcirc$  $\bigcirc$ 

Drawing title:

TYPICAL DETAILS

approvals:

MUNICIPALITY APPROVAL



6 - 14 - 2022



revisions:


ADU SIZE REDUCED DATE 11-21-2022

 $\approx$ 


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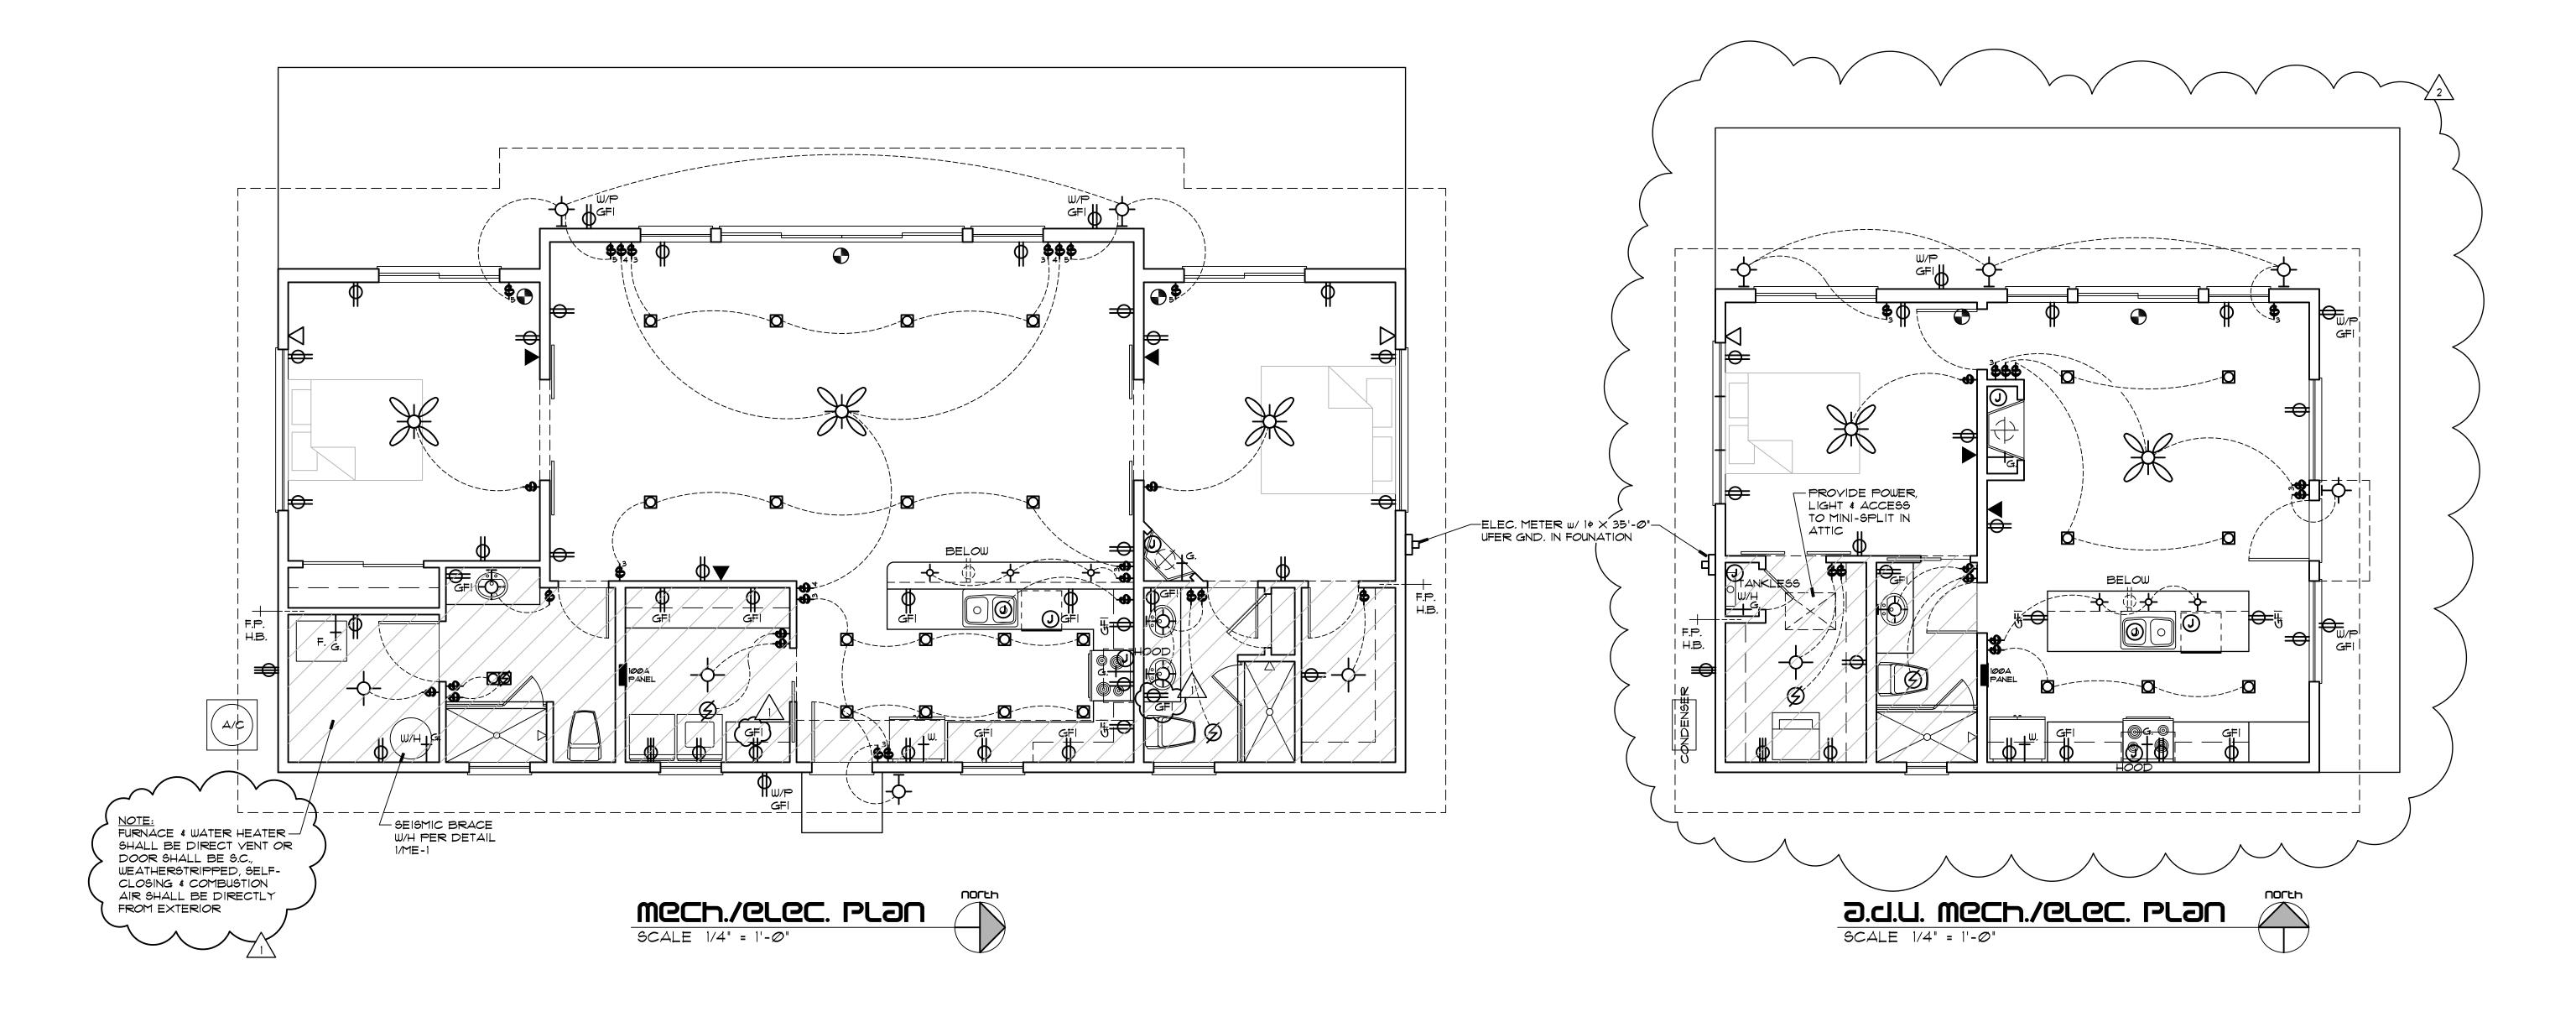
FOUNDATION PLAN DETAILS




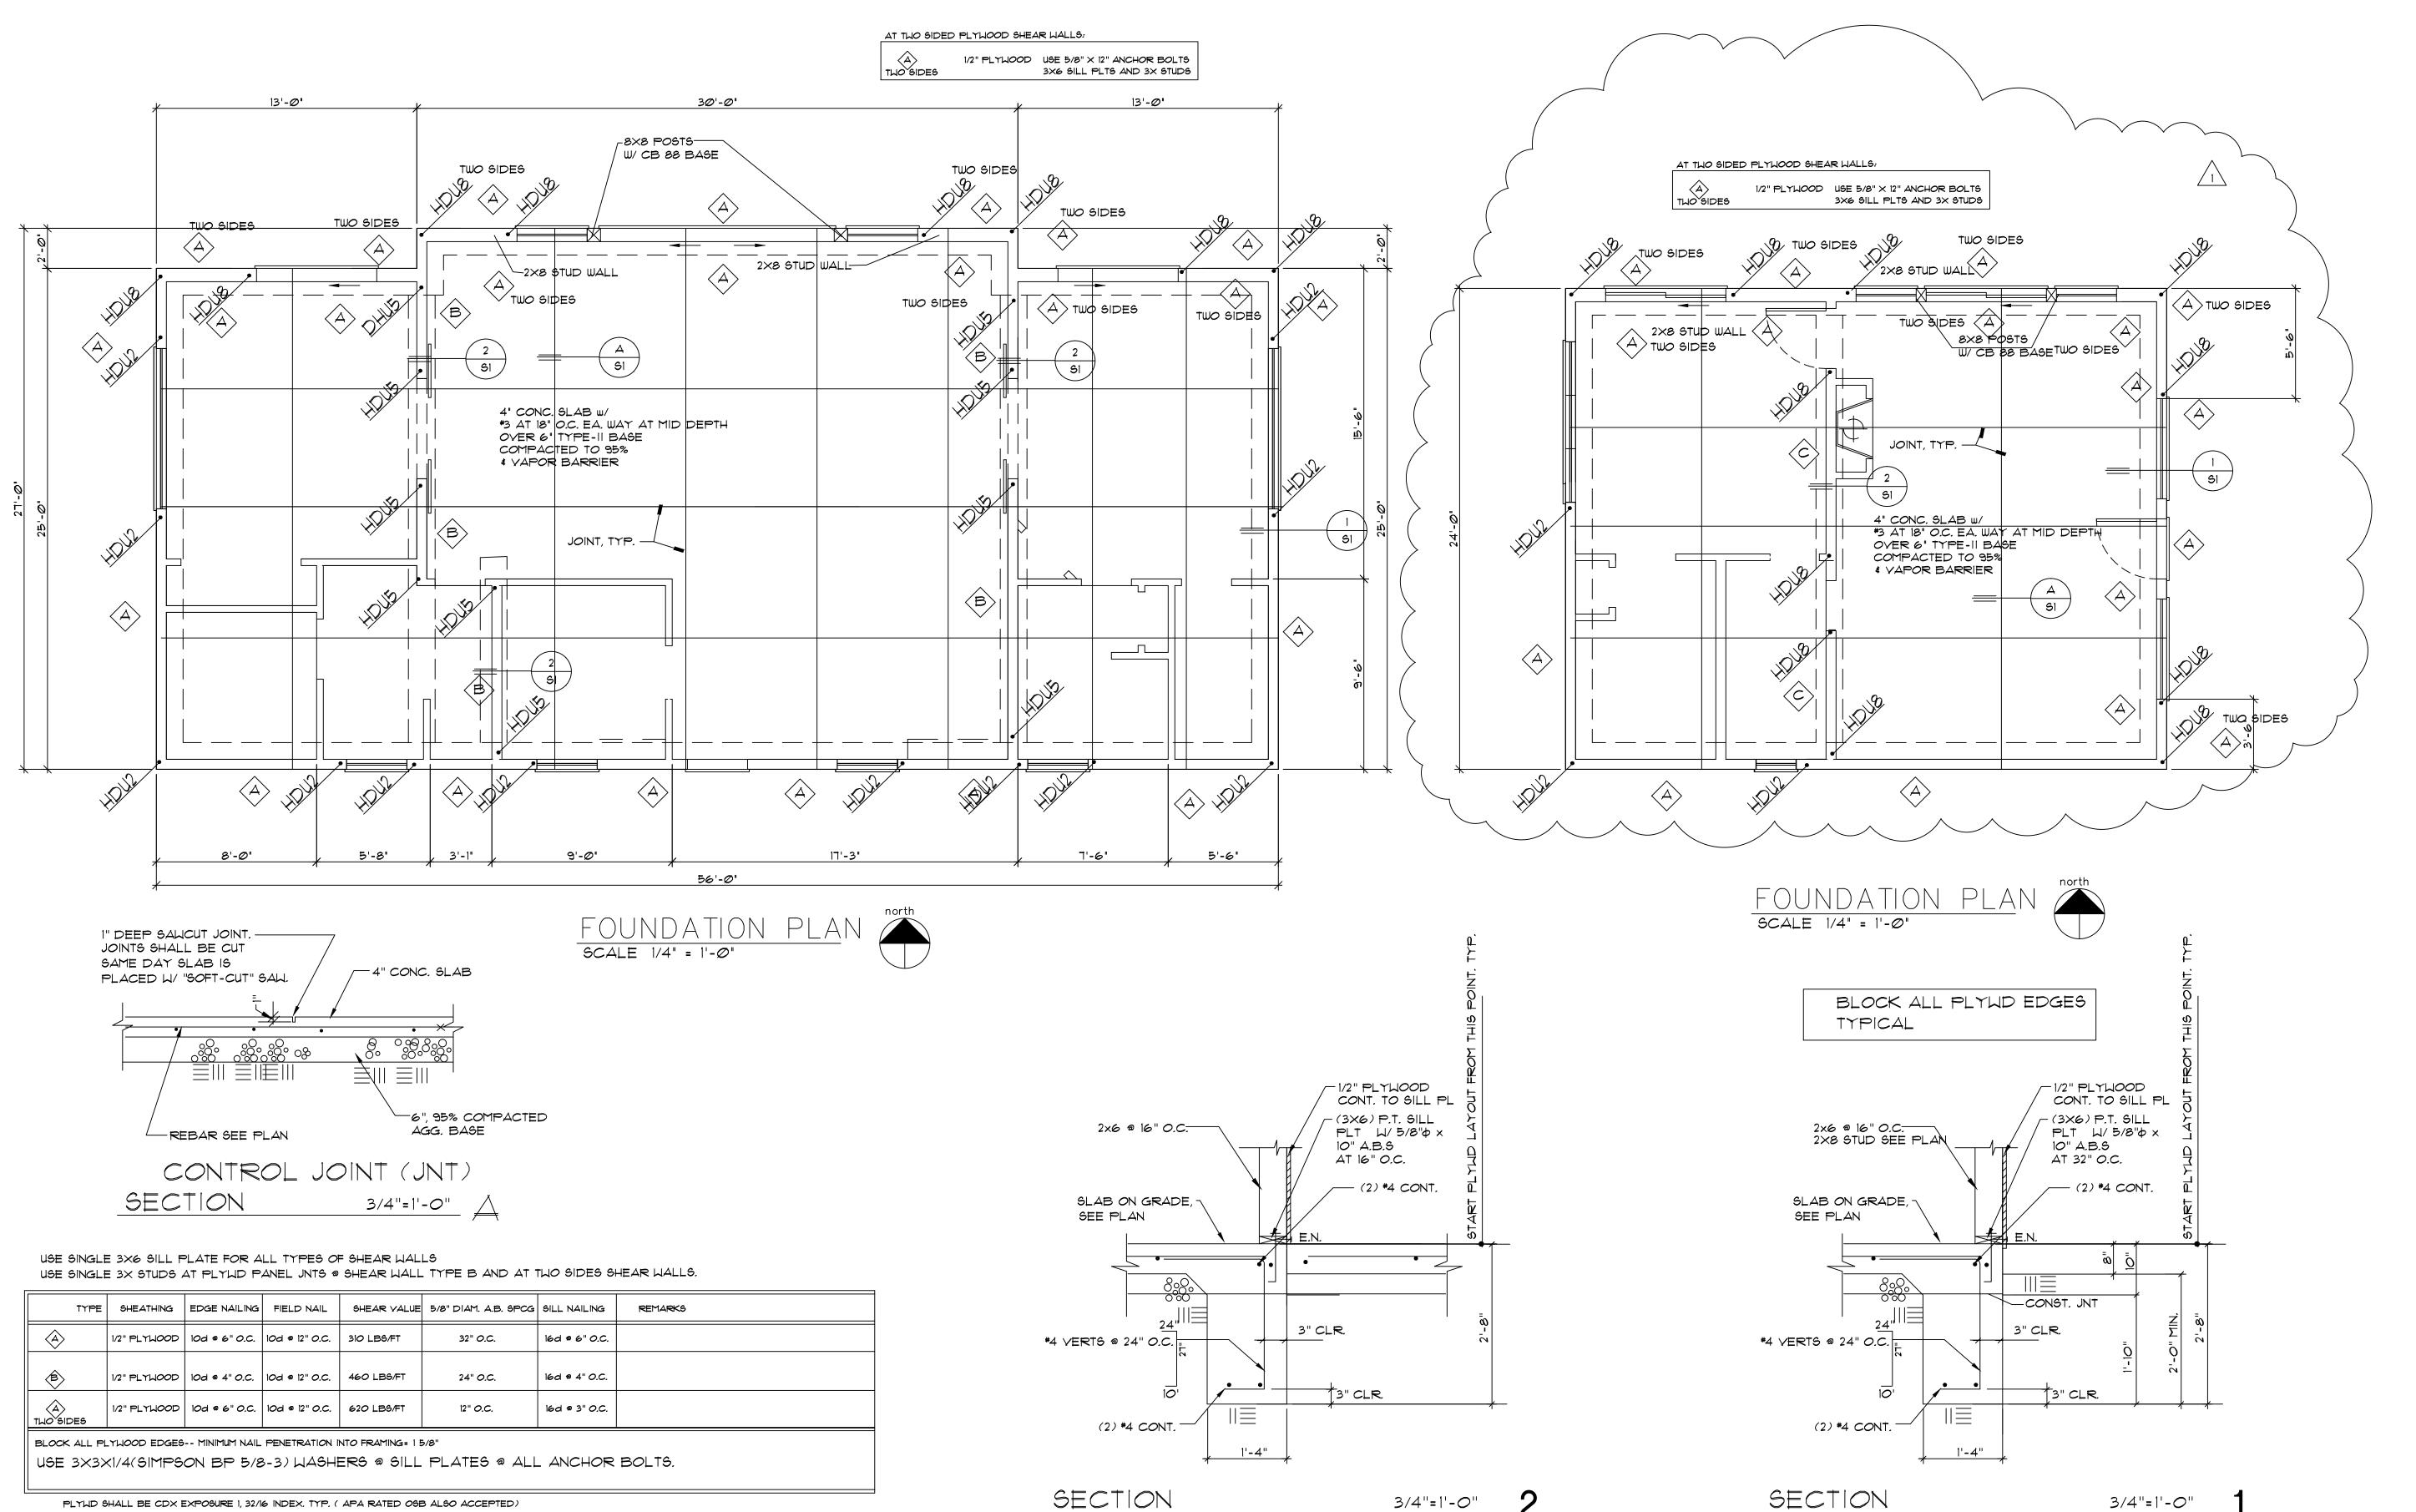


PLYUD SHALL BE CDX EXPOSURE 1, 32/16 INDEX. TYP. ( APA RATED 05B ALSO ACCEPTED) 10d COMMON NAIL SHALL HAVE 0.148 DIAMETER. ALL NAIL SHALL BE COMMOM NAIL UNO.



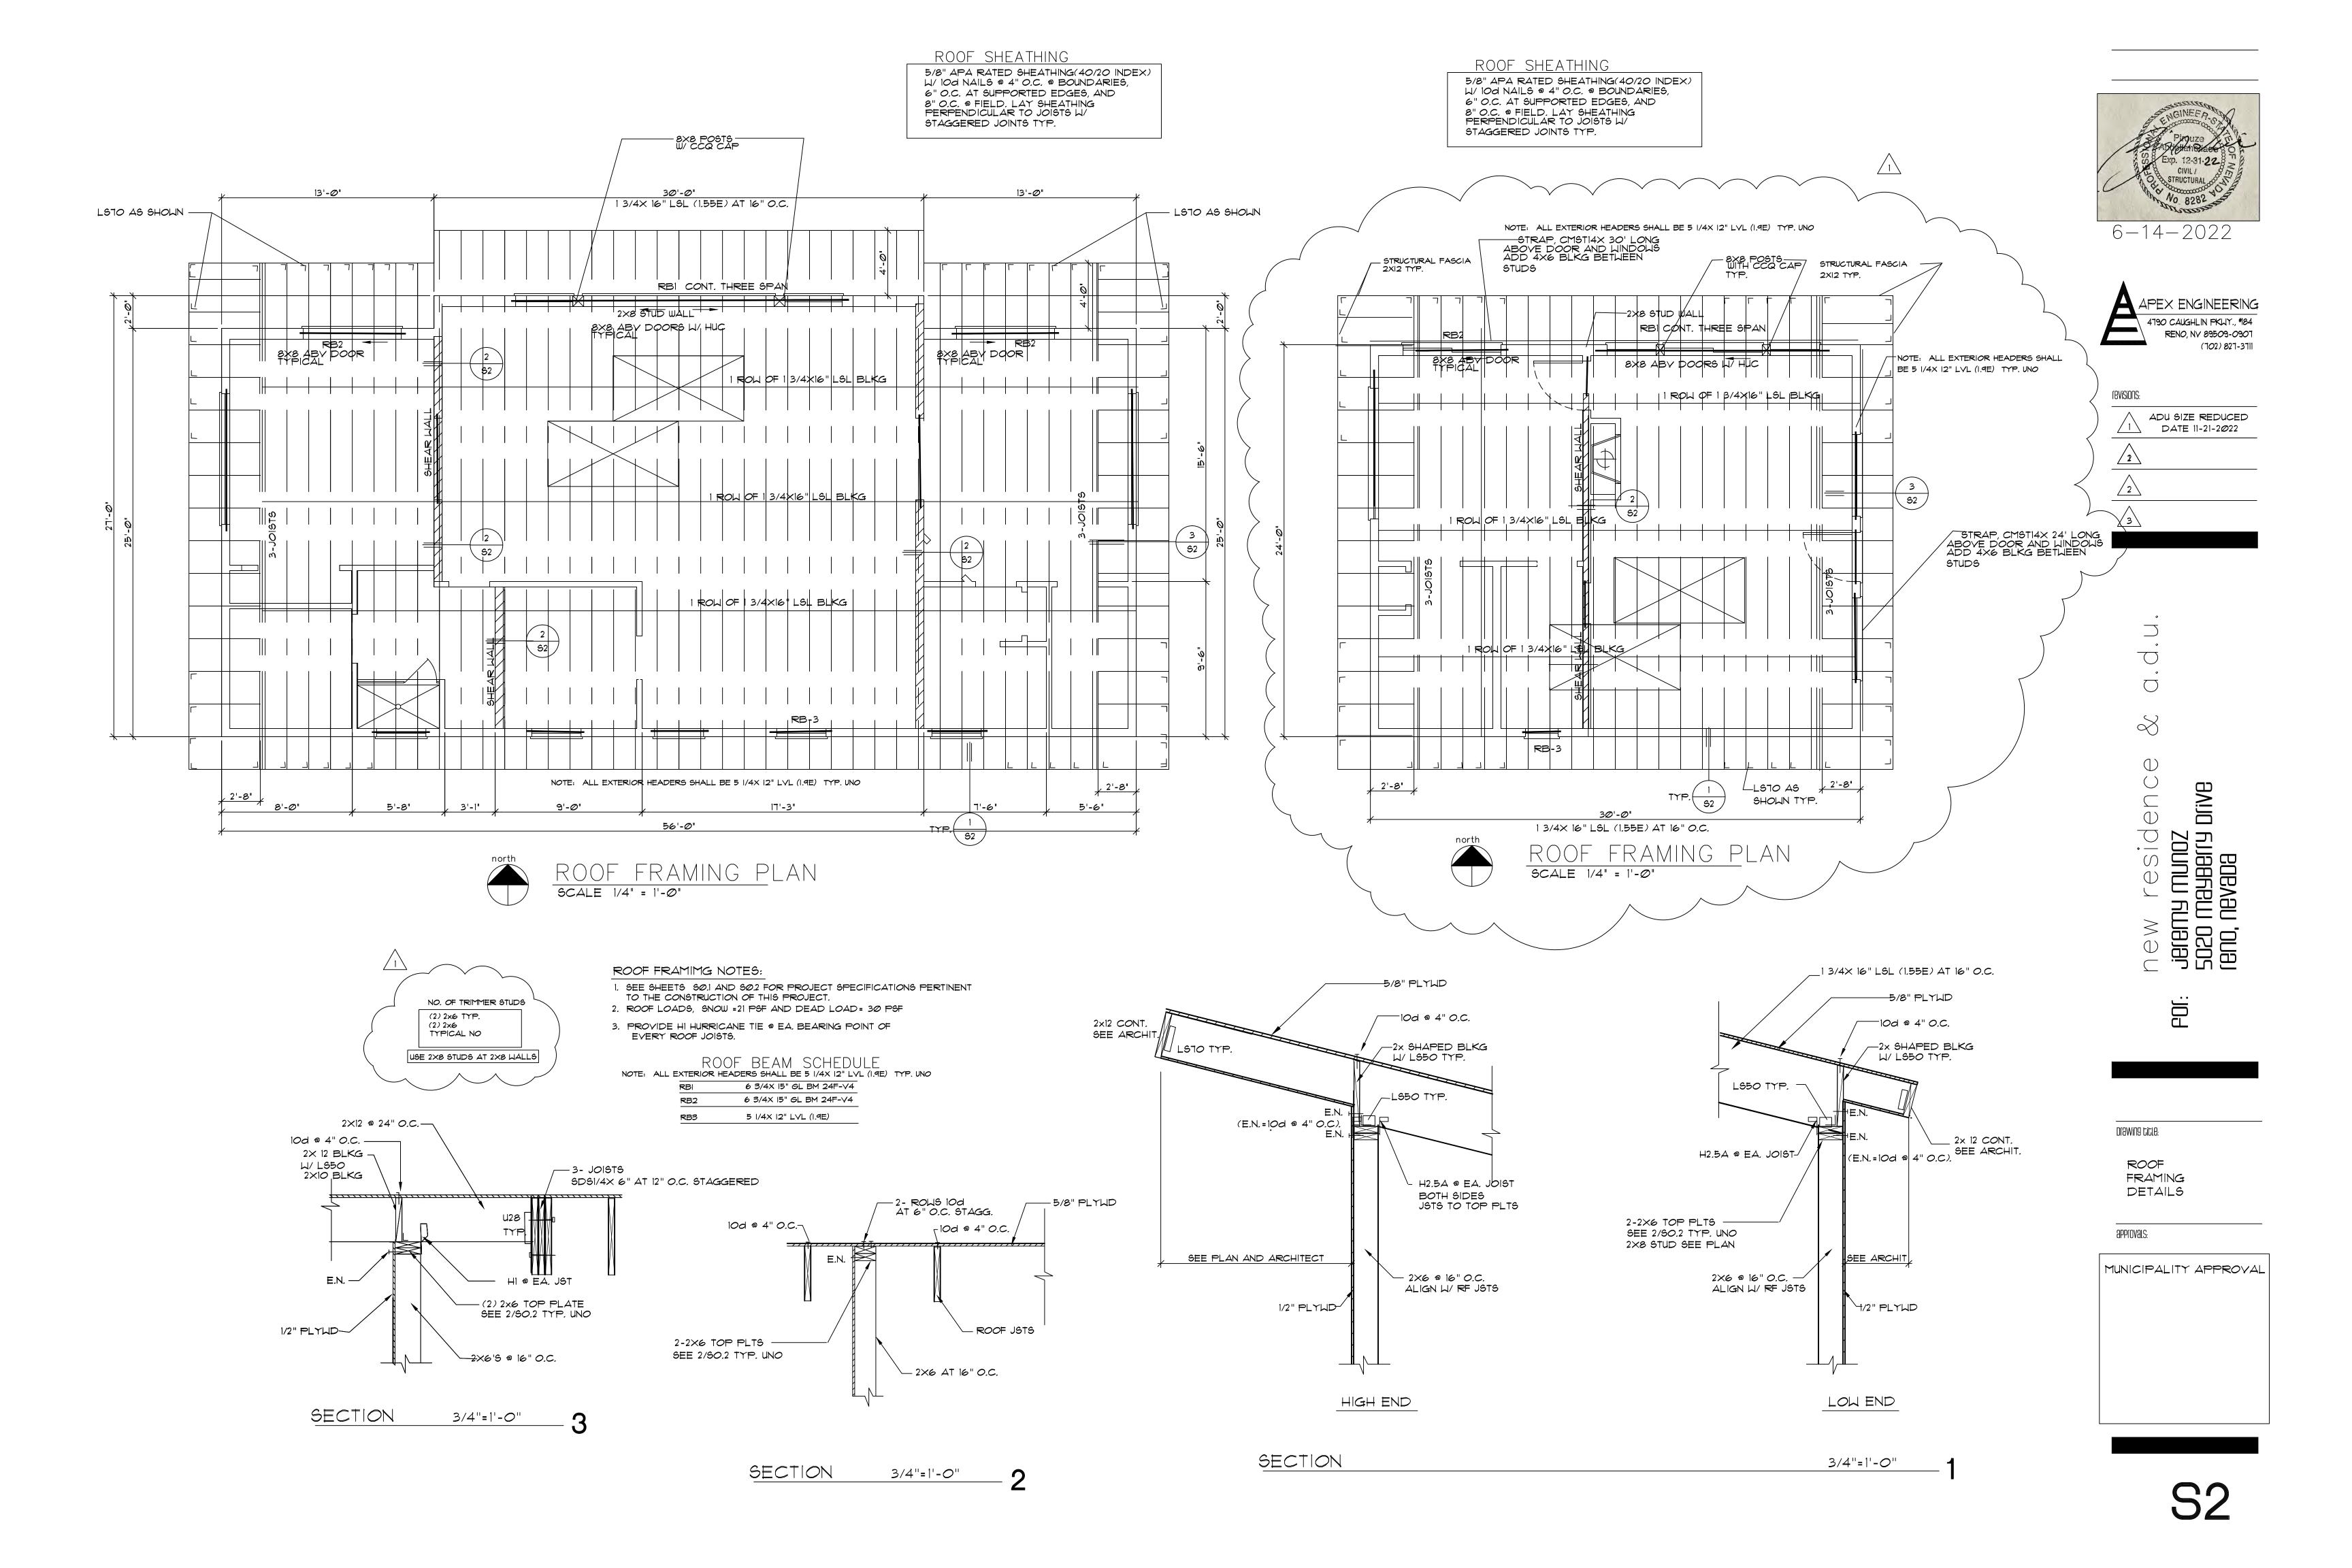

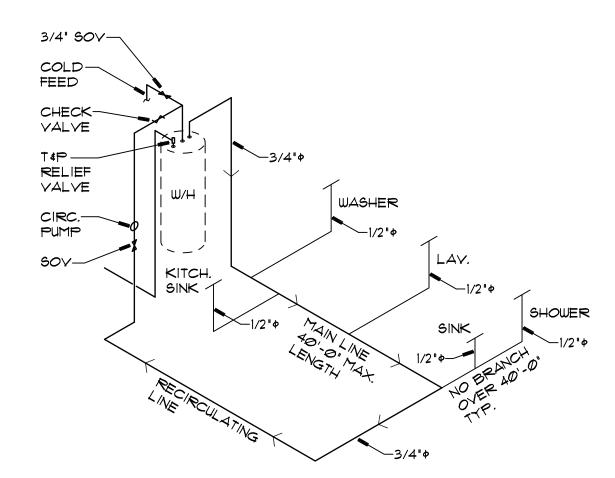

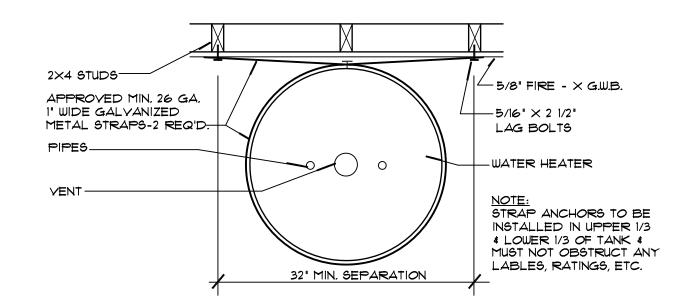

### W/h seismic bracing NO SCALE

## HOT MSTEL CILCULSTION SYSTEM (SCHEMOTIC OULY)

NO SCALE

### NOTES:

ALL DISTANCES OFF MAIN LOOP SHALL BE LESS THAN 40'-0". 2. 3/4" PIPE SHALL BE INSUL.  $\omega$ / 'IMCOLOCK' 1/8"  $\times$  1/2" WALL (R = 2.96). 3. 1/2" PIPE SHALL BE INSUL. w/ 'IMCOLOCK' 5/8"  $\times$  1/2" WALL (R = 3.07).

CALCULATIONS: MAXIMUM WATER TEMPERATURE = 140° F.

DESIGN AMBIENT TEMPERATURE = 65° F. DELTA 'T' = 75° F.

DELTA 'T' / 25 BTUH/S.F. = 1/R REQ'D. 75° / 25 BTUH = 3 = .33R REQ'D. 1/2" CLOSED CELL FOAM INSUL. = .5R > .33R = O.K.

### MCCh./CLCC. LC9CNd:

110 V. DUPLEX OUTLET - GFI WHERE NOTED

110 V. 4-PLEX OUTLET - GFI WHERE NOTED

110 Y. DUPLEX OUTLET - HALF SWITCHED

110 V. "J" BOX

220 Y. OUTLET (PROVIDE DISCONNECT @ A/C CONDENSER)

SWITCH - DIMMER (D): 3-WAY (3): AS NOTED.

RECESSED LIGHT - PROVIDE DIMMERS @ ALL CIRCUITS & LENSES IN WATER AREAS, CLOSETS & @ EXTERIOR.

LOW-VOLTAGE DIRECTIONAL SPOTLIGHT

SURFACE MOUNTED LIGHT - CHANDELIER (CH)

WALL MOUNTED LIGHT

FAN OR FAN/LIGHT - V.T.O.


FAN/HEAT LAMP COMBINATION UNIT

SMOKE/CO DETECTOR - 110 V.

TELEPHONE - CATEGORY 5 WIRING

CABLE T.V. - RG 6 WIRING



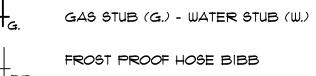

### Mech./elec. notes:

1. ALL WORK SHALL BE IN ACCORDANCE WITH THE I.R.C./I.B.C. AS AMENDED BY THE LOCAL GOVERNING AUTHORITY.

2. ALL SWITCHES SHALL BE LOCATED CLEAR OF DOOR SWINGS.

3. ALL SLEEPING ROOM OUTLETS SHALL BE ARC-FAULT PROTECTED.

4. PROVIDE SMOKE DETECTORS W/ BATTERY BACK-UP WHERE NOTED INTER-CONNECT ALL SMOKE DETECTORS.

5. PROVIDE DBL. SWITCHES TO ALL DECORATIVE FAN/LIGHTS.

6. ALL EXTERIOR OUTLETS & FIXTURES SHALL BE WATERPROOF &

ALL EXTERIOR LIGHTING SHALL BE ON DIMMER CIRCUITS, TYP.

1. MAX. LENGTH OF HVAC FLEX-DUCT NOT TO EXCEED 25'-0".

8. SEE SHEET A-2 FOR ANY MINOR MODIFICATIONS TO FLOOR PLAN. 9. ALL 120V, 15A \$ 20A OUTLETS IN THE FOLLOWING LOCATIONS SHALL BE ARC-FAULT PROTECTED: FAMILY RM., DINING RM., LIVING RM.,

ROOMS, CLOSETS, HALLWAYS & SIMILAR ROOMS OR AREAS. SEE ALSO NOTE #10 BELOW. 10. ALL 120V, 15A \$ 20A OUTLETS LOCATED BELOW 5'-6" A.F.F. SHALL

PARLOR, LIBRARIES, DENS, BEDROOMS, SUNROOMS, RECREATION

BE TAMPER-RESISTANT PER THE NEC.

11. PROVIDE THE FOLLOWING MIN. BRANCH CIRCUITS: 2-20A TO KITCHENS, 1-20A TO LAUNDRY \$ 1-20A TO BATHROOM.

12. A MIN. OF 50% OF LAMPS IN PERMANENTLY INSTALLED FIXTURES SHALL BE HIGH EFFICACY LAMPS.

13. A/C DISCONNECTS SHALL BE LOCATED SUCH THAT THE REQ'D. CLEARANCE OF 36" IN FRONT & 30" WIDTH IS MAINTAINED FROM GROUND OR SLAB TO A HT. OF 61/2 FT.

14. DRYER VENT TERMINATION SHALL BE INSTALLED PER MANUF., MIN. 4" P W/ DAMPER & MIN. 3 FT. SEPARATION TO OPENINGS IN ANY DIRECTION.

15. INSTALL ALL PIPING & VENTS IN EXTERIOR WALLS ON WARM SIDE OF INSULATION, TYP.

alchitect

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6-6-52

9-8-22 1 PLANCHECK


12-5-22 ADU SIZE REDUCTION


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all designs ¢ drawings as instruments of service are COPYTIGHT BY THE ATCHITECT UNDER PROVISIONS OF NES 629. UNAUTHORIZED DUPLICATION OF Designs of Distrubution of Drawings is ProHiBited.


Drawing title

MECH./ELEC. PLAN



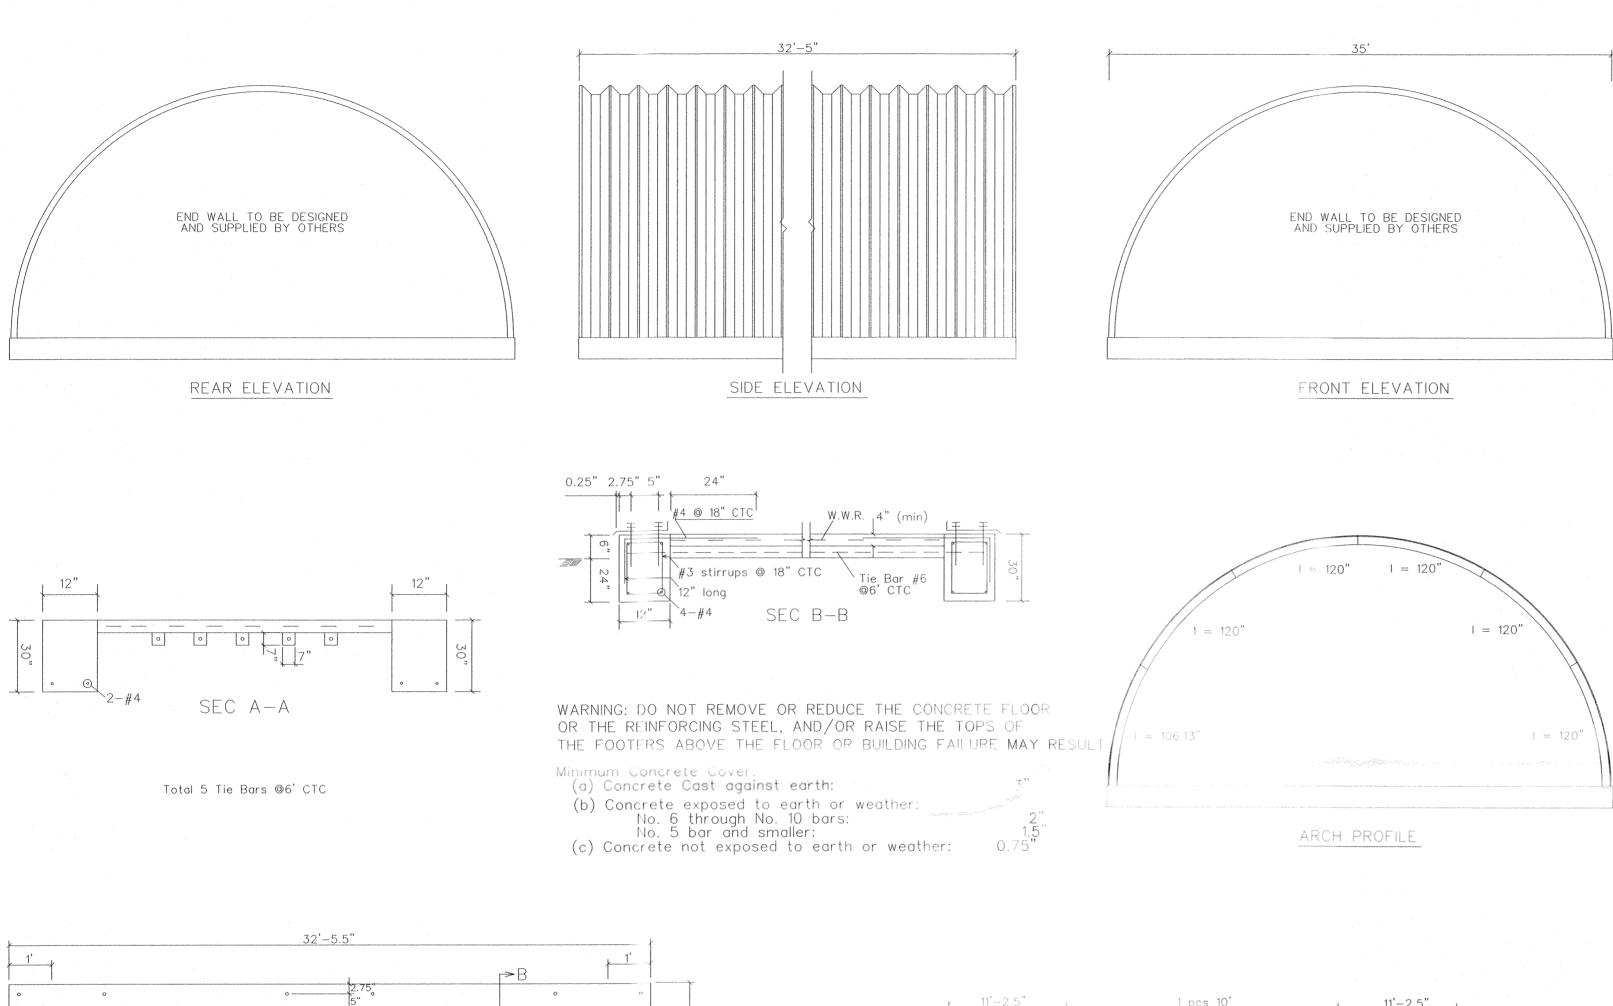

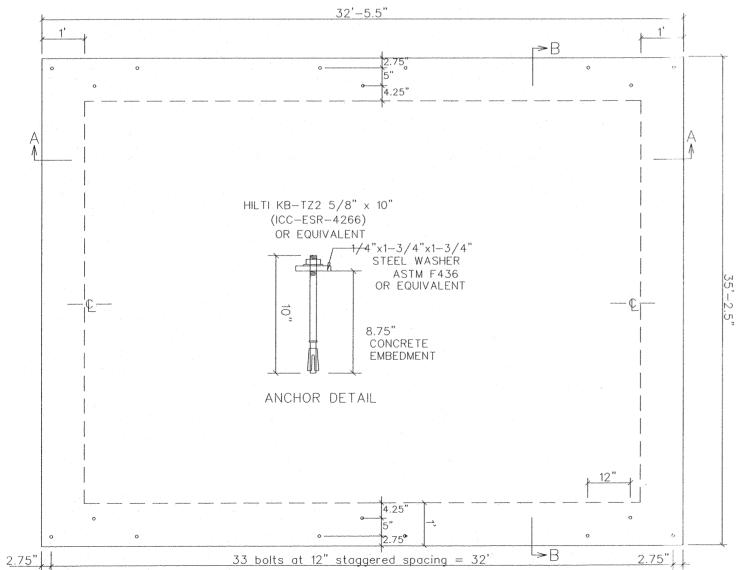FOUNDATION PLAN

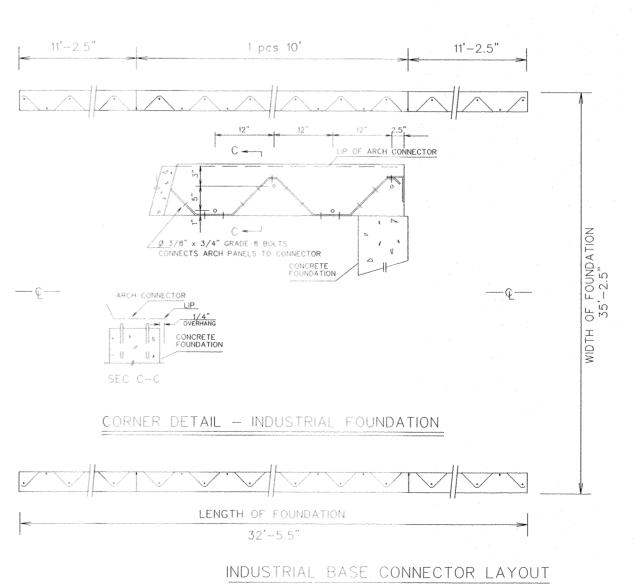

LEGAL NOTE
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1. ALL MATERIAL AND WORKMANSHIP SHALL CONFORM WITH THE REQUIREMENTS OF THE LATEST REVISION OF THE INTERNATIONAL BUILDING CODE 2018, DESIGN ACCORDING TO AISI S100-16W/S1-18, NORTH AMERICAN SPECIFICATION FOR THE DESIGN OF COLD-FORMED STEEL STRUCTURAL

2. NO LOADS OTHER THAN THOSE GIVEN UNDER "DESIGN

DATA" BELOW SHALL BE IMPOSED ON THE "STRUCTURE" 3. SPECIFIC NOTES AND DETAILS SHOWN ON THE DRAWINGS SHALL TAKE PRECEDENCE OVER THE BUILDING MANUAL

4. THE BUILDING, INCLUDING THE FOUNDATION, MUST BE CONSTRUCTED IN STRICT ACCORDANCE WITH THE DRAWING AND ERECTION INSTRUCTIONS, ANY DEVIATION, UNLESS APPROVED BY US IN WRITING, SHALL NULLIFY OUR CERTIFICATE AND SEAL AND SHALL BE THE SOLE

5. A PROFESSIONAL ENGINEER SHOULD BE RETAINED

6, NO ARCH PANEL MAY BE CUT OR MODIFIED UNLESS IT IS TO ACCOMMODATE AN ACCESSORY PROVIDED BY THE MANUFACTURER IN ACCORDANCE WITH ITS INSTRUCTIONS

, MINIMUM SEPARATION FROM THIS BUILDING TO ANY TALLER BUILDING MUST BE THE SMALLER OF 20 FEET

NOTE: THE FOUNDATION ON THE DRAWING SPECIFIES THE MINIMUM REQUIREMENTS. LOCAL BUILDING CODE AND SITE CONDITIONS MAY REQUIRE A STRONGER FOUNDATION, WHICH MUST BE DESIGNED BY A LOCAL ENGINEER. 1. THE FOUNDATION SHALL BE FOUNDED ON NATURAL UNDISTURBED SOIL CAPABLE OF SAFELY SUSTAINING

1500 psf. THIS SHALL BE DESIGNED TO FULLY RESIST

2. SLAB ON GRADE SHALL BE PLACED ON WELL COMPACTED

2. REINFORCING STEEL GRADE 40, Fy # 40 KSI, ASTM A615

24"

STRUCTURAL QUALITY ASTM SPECIFICATION A792-10 (2015)

ARCH DESIGN DATA IN ACCORDANCE WITH ANSI/ASCE 7-16:

55% ALUMINUM-ZINC ALLOY (HOT DIP COATING)

ASTM A992 GRADE 50 (Fy = 50 ksi) OTHER SECTIONS SHALL CONFORM TO: ASTM A36 (Fy = 36 ksi)

Pnet: COMPONENT WIND PRESSURE (PSF) =  $\pm /-27$ 

GCpi: PRODUCT OF INTERNAL PRESSURE COEFFICIENT

AND GUST-EFFECT FACTOR = +/- 0.18

ALL ROTATION AT THE BASE OF THE ARCH.

1. CONCRETE F'c = 2500 PSI @ 28 DAYS, ACI

3. W.W.R. Fy = 65 KSI, ASTM A1064. 4. W.W.R. 6 x 6 - W1.4 x W1.4

BOLTS: SAE GRADE 2 OR ASTM A307

HSS SECTIONS SHALL CONFORM TO: ASTM A500 GRADE B (Fy = 46 ksi)

W SECTIONS SHALL CONFORM TO:

Lo: ROOF LIVE LOAD (PSF) = 21 Pg: GROUND SNOW LOAD (PSF) = 42Ce: EXPOSURE FACTOR = 1.1 Ct: THERMAL FACTOR = 1.0 IMPORTANCE FACTOR (SNOW) = 1.0

V : BASIC WIND SPEED (MPH) = 120

Kzt: TOPOGRAPHIC FACTOR = 1.0

Ke: Ground Elevation Factor = 1.00 WIND EXPOSURE CATEGORY = C SEISMIC DESIGN CATEGORY = E

Kh: VELOCITY PRESSURE EXPOSURE = 0.85

Kd: WIND DIRECTIONALITY FACTOR = 0.85

CATEGORY II BUILDING

ROOF STEEL THICKNESS = 0.05 in.

GALVALUME SHEET STEEL

ASTM A792 GRADE 50A 50 KSI MINIMUM YIELD 65 KSI MINIMUM TENSILE

SOIL CAPABLE OF SUSTAINING 1500 psf WITHOUT

8. IF SEALED BY AN ENGINEER, THIS DRAWING IS FOR PERMIT APPLICATION, OTHERWISE IT IS A DRAFT

WHERE SITE INSPECTIONS ARE WARRANTED.

AND 6 TIMES THE HEIGHT DIFFERENCE.

AND NOT FOR CONSTRUCTION.

FOUNDATION NOTES

APPRECIABLE SETTLEMENT. DESIGN DATA (MATERIALS)

ARCH DATA

MEMBERS, AND WITH ANSI/ASCE 7-16.

RESPONSIBILITY OF THE ERECTOR.