

Washoe County Development Application

Your entire application is a public record. If you have a concern about releasing personal information, please contact Planning and Building staff at 775.328.6100.

Project Information		Staff Assigned Case No.: _____	
Project Name: Bordertown Casino Expansion			
Project Description: A phased project to expand the existing Bordertown Casino			
Project Address: 19575 US Highway 395 N Washoe County, NV 89508			
Project Area (acres or square feet): 29,785			
Project Location (with point of reference to major cross streets AND area locator): Northwest of the Village Pkwy/US 395 exit in the Cold Springs area.			
Assessor's Parcel No.(s):	Parcel Acreage:	Assessor's Parcel No.(s):	Parcel Acreage:
081-140-16	12.37		
Indicate any previous Washoe County approvals associated with this application: Case No.(s). SW05-018			
Applicant Information (attach additional sheets if necessary)			
Property Owner:		Professional Consultant:	
Name: Bordertown Properties LLC		Name: Frank Lepori Construction	
Address: 19575 US Highway 395 N		Address: 1580 Hymer Ave	
Washoe County, NV	Zip: 89508	Sparks, NV	Zip: 89431
Phone: 775-972-1309	Fax:	Phone: 775-337-2063	Fax:
Email: greg@bordertowncasinorv.com		Email: dominic@leporiconstruction.com	
Cell:	Other:	Cell: 775-762-9351	Other:
Contact Person: Greg Gardner		Contact Person: Dominic Gonzales	
Applicant/Developer:		Other Persons to be Contacted:	
Name: Frank Lepori Construction		Name:	
Address: 1580 Hymer Ave		Address:	
Sparks, NV 89431	Zip:		Zip:
Phone: 775-337-2063	Fax:	Phone:	Fax:
Email: dominic@leporiconstruction.com		Email:	
Cell: 775-762-9351	Other:	Cell:	Other:
Contact Person: Dominic Gonzales		Contact Person:	
For Office Use Only			
Date Received:	Initial:	Planning Area:	
County Commission District:		Master Plan Designation(s):	
CAB(s):		Regulatory Zoning(s):	

Special Use Permit Application Supplemental Information

(All required information may be separately attached)

1. What is the project being requested?

A phased project to expand the unlimited gaming use type of Bordertown Casino. Phase 1 includes a 17,470 sq ft new building adjacent to the existing building on the existing lot. Phase 2 includes moving operations into the new building, demolishing the existing building, and constructing an addition that will tie into the Phase 1 building. A new 29,785 sq ft building will be the final product of Phase 1 + Phase 2

2. Provide a site plan with all existing and proposed structures (e.g. new structures, roadway improvements, utilities, sanitation, water supply, drainage, parking, signs, etc.)

Site Plan provided in this application

3. What is the intended phasing schedule for the construction and completion of the project?

Phase 1 will begin pending issuance of all required building permits during the 4th quarter of 2023. Phase 2 to begin upon the completion of Phase 1 with a completion of project in 2024.

4. What physical characteristics of your location and/or premises are especially suited to deal with the impacts and the intensity of your proposed use?

The existing characteristics of the current Bordertown location are already suited to deal with the impacts and intensity of the proposed use. Bordertown has not had an update since initial construction in 1979. An expansion was previously proposed and the majority of the site work was completed at that time. While the expansion never came to fruition, the community seemed eager to revisit the concept and looks forward to a nice, new building at an already busy and loved location.

5. What are the anticipated beneficial aspects or affects your project will have on adjacent properties and the community?

The project was well received at the Neighborhood meeting and a new building will enhance the already popular and existing establishment.

6. What are the anticipated negative impacts or affect your project will have on adjacent properties? How will you mitigate these impacts?

We do not anticipate any negative impacts on the adjacent properties

7. Provide specific information on landscaping, parking, type of signs and lighting, and all other code requirements pertinent to the type of use being purposed. Show and indicate these requirements on submitted drawings with the application.

Code current and required landscaping, parking and lighting are already integrated into the existing site layout and establishment as it pertains to Phase 1 of this project. New building signage will be added at proposed entrances into the establishment. Additional landscaping and parking adhering to code requirements will be provided as part of Phase 2 with additional signage at the grand entrance. All landscaping, parking and lighting requirements are included on the plans as part of this application for the entire build-out (Phase 1 + Phase 2).

8. Are there any restrictive covenants, recorded conditions, or deed restrictions (CC&Rs) that apply to the area subject to the special use permit request? (If so, please attach a copy.)

<input type="checkbox"/> Yes	<input checked="" type="checkbox"/> No
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9. Utilities:

a. Sewer Service	Municipal, Washoe County
b. Electrical Service	NV Energy
c. Telephone Service	Verizon
d. LPG or Natural Gas Service	LPG
e. Solid Waste Disposal Service	Waste Management
f. Cable Television Service	Charter Spectrum
g. Water Service	Great Basin Water Company

For most uses, Washoe County Code, Chapter 110, Article 422, Water and Sewer Resource Requirements, requires the dedication of water rights to Washoe County. Please indicate the type and quantity of water rights you have available should dedication be required.


h. Permit #		acre-feet per year	
i. Certificate #		acre-feet per year	
j. Surface Claim #		acre-feet per year	
k. Other #		acre-feet per year	

Title of those rights (as filed with the State Engineer in the Division of Water Resources of the Department of Conservation and Natural Resources).

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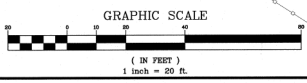
10. Community Services (provided and nearest facility):

a. Fire Station	Truckee Meadows Fire and Rescue Station 42
b. Health Care Facility	Community Health Alliance - North Valleys Health Center
c. Elementary School	Nancy Gomes Elementary School
d. Middle School	Cold Springs Middle School
e. High School	North Valleys High School
f. Parks	Sierra Rock Park
g. Library	North Valleys Library
h. Citifare Bus Stop	Lear Boulevard and Moya Boulevard

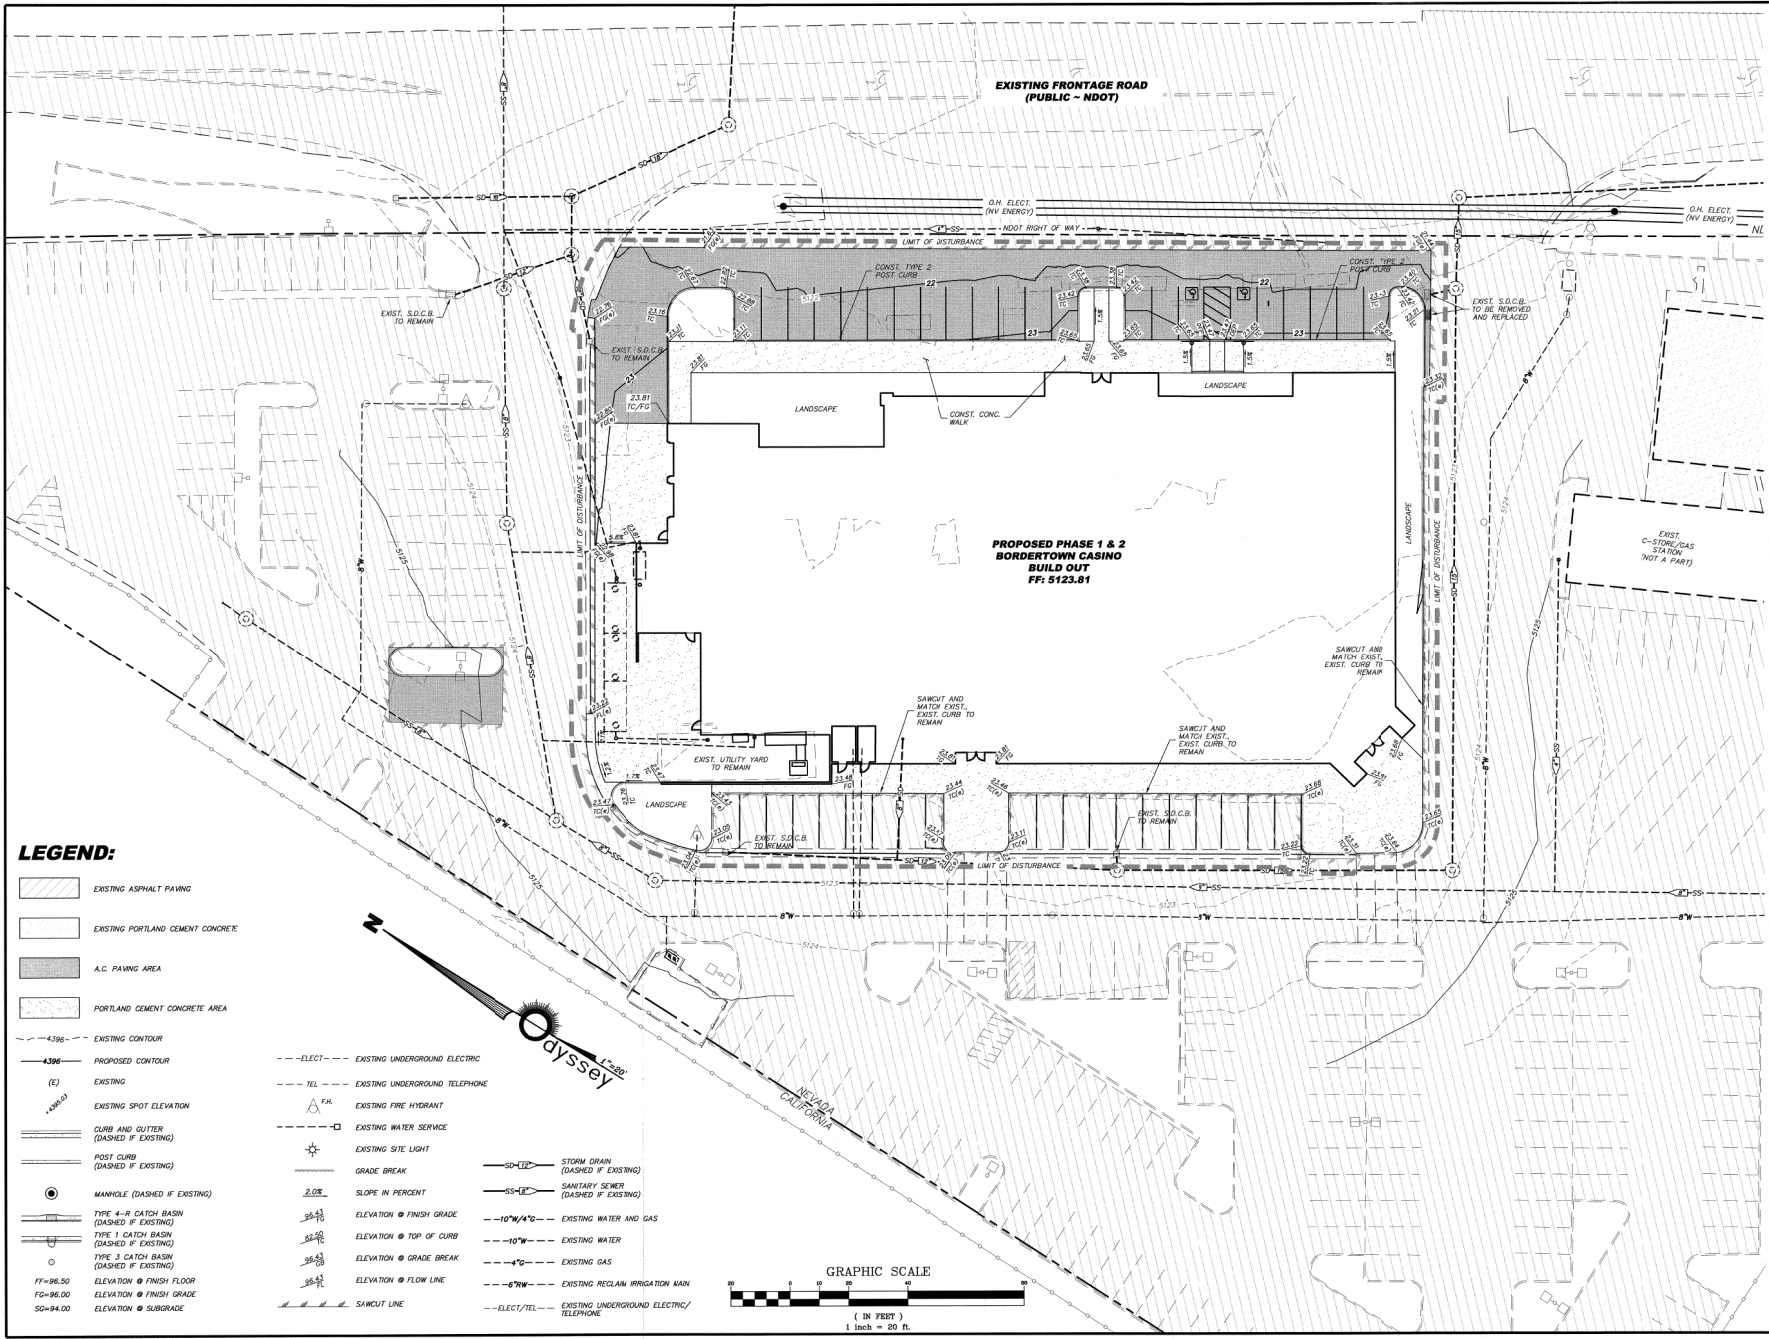

LEGEND:

- EXISTING ASPHALT PAVING
- EXISTING PORTLAND CEMENT CONCRETE
- A.C. PAVING AREA
- PORTLAND CEMENT CONCRETE AREA
- 4.396 - EXISTING CONTOUR
- 4.396 - PROPOSED CONTOUR
- (E) EXISTING
- 4.96.00 EXISTING SPOT ELEVATION
- CURB AND GUTTER (DASHED IF EXISTING)
- POST CURB (DASHED IF EXISTING)
- MANNHOLE (DASHED IF EXISTING)
- TYPE 4-R CATCH BASIN (DASHED IF EXISTING)
- TYPE 1 CATCH BASIN (DASHED IF EXISTING)
- TYPE 3 CATCH BASIN (DASHED IF EXISTING)
- FF-96.50 ELEVATION @ FINISH FLOOR
- FD-96.00 ELEVATION @ FINISH GRADE
- SD-94.00 ELEVATION @ SUBGRADE
- ELECT- EXISTING UNDERGROUND ELECTRIC
- TEL- EXISTING UNDERGROUND TELEPHONE
- F.R. EXISTING FIRE HYDRANT
- EXISTING WATER SERVICE
- EXISTING SITE LIGHT
- GRADE BREAK
- 2.0% SLOPE IN PERCENT
- ELEVATION @ FINISH GRADE
- ELEVATION @ TOP OF CURB
- ELEVATION @ GRADE BREAK
- ELEVATION @ FLOW LINE
- SAWCUT LINE
- SD-TXZ STORM DRAIN (DASHED IF EXISTING)
- SS-TXZ SANITARY SEWER (DASHED IF EXISTING)
- 10"W/4" EXISTING WATER AND GAS
- 10"W EXISTING WATER
- 4" EXISTING GAS
- 6" EXISTING RECLAIM IRRIGATION MAIN
- ELECT/TEL- EXISTING UNDERGROUND ELECTRIC/TELEPHONE



NOT FOR CONSTRUCTION

BORDERTOWN CASINO
SPECIAL USE PERMIT
CIVIL GRADING PLAN

805 BORDERTOWN BLVD., SUITE 104, SPARKS, NV 89431
(775) 306-3303 FAX (775) 306-3328
www.odysseyengineering.com

ODYSSEY
ENGINEERING
INCORPORATED


SCALE
HORIZ.
VERT.

SHEET
C2.1
OF
2

REV.	DATE	DESCRIPTION

DATE: 06/20/24
DRAWN BY: CIVIL20240
DESIGNED BY: FCT
CHECKED BY: FCT

NEVADA
WASHOE COUNTY

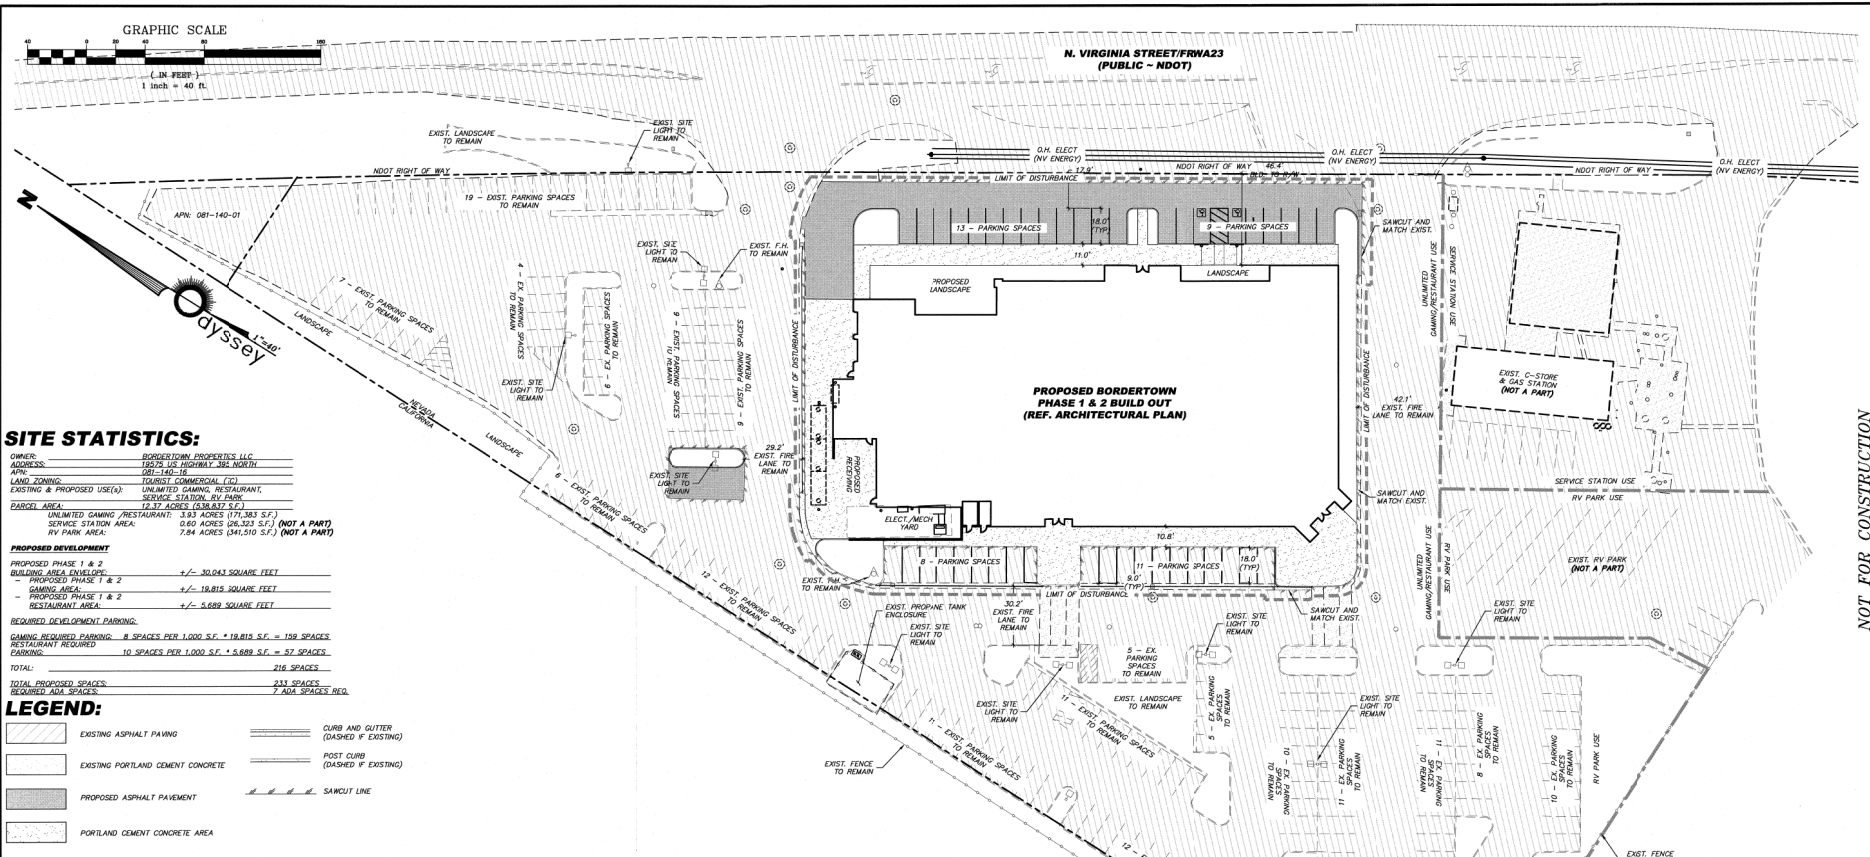

SITE STATISTICS:

OWNER: BORDERTOWN PROPERTIES LLC
 ADDRESS: 1870 S. LAS VEGAS BLVD. NORTH
 APN: 081-140-16
 LAND ZONING: UNLIMITED COMMERCIAL (UC)
 EXISTING & PROPOSED USE(s): UNLIMITED GAMING, RESTAURANT, SERVICE STATION, RV PARK
 PARCEL AREA: 12.37 ACRES (538,837 S.F.)
 UNLIMITED GAMING RESTAURANT: 3.83 ACRES (171,963 S.F.) (NOT A PART)
 SERVICE STATION AREA: 0.60 ACRES (26,323 S.F.) (NOT A PART)
 RV PARK AREA: 7.94 ACRES (341,510 S.F.) (NOT A PART)

PROPOSED DEVELOPMENT

PROPOSED PHASE 1 & 2 BUILDING AREA ENVELOPE: +/- 30,043 SQUARE FEET
 - PROPOSED PHASE 1 & 2 GAMING AREA: +/- 19,815 SQUARE FEET
 - PROPOSED PHASE 1 & 2 RESTAURANT AREA: +/- 5,689 SQUARE FEET


REQUIRED DEVELOPMENT PARKING:

GAMING REQUIRED PARKING: 8 SPACES PER 1,000 S.F. * 19,815 S.F. = 159 SPACES
 RESTAURANT REQUIRED PARKING: 10 SPACES PER 1,000 S.F. * 5,689 S.F. = 57 SPACES
 TOTAL: 216 SPACES


TOTAL PROPOSED SPACES: 216 SPACES
 REQUIRED ADDL SPACES: 7 ADDL SPACES REQ.

LEGEND:

	EXISTING ASPHALT PAVING		CURB AND GUTTER (DASHED IF EXISTING)
	EXISTING PORTLAND CEMENT CONCRETE		POST CURB (DASHED IF EXISTING)
	PROPOSED ASPHALT PAVEMENT		SAWCUT LINE
	PORTLAND CEMENT CONCRETE AREA		

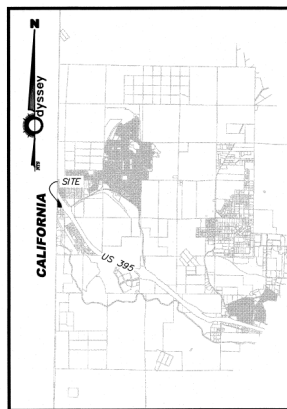

VICINITY MAP SCALE: N.T.S.

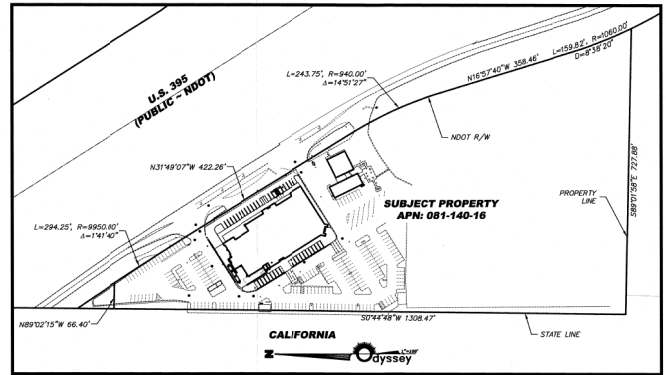

SITE MAP SCALE: 1"=150'

REV.	DATE	DESCRIPTION
1	07/25/2020	ISSUED FOR PERMIT
2	08/10/2020	REVISED PER COMMENTS
3	08/20/2020	REVISED PER COMMENTS
4	09/01/2020	REVISED PER COMMENTS
5	09/15/2020	REVISED PER COMMENTS
6	09/30/2020	REVISED PER COMMENTS
7	10/15/2020	REVISED PER COMMENTS
8	10/30/2020	REVISED PER COMMENTS
9	11/15/2020	REVISED PER COMMENTS
10	11/30/2020	REVISED PER COMMENTS
11	12/15/2020	REVISED PER COMMENTS
12	12/31/2020	REVISED PER COMMENTS

NOT FOR CONSTRUCTION

**BORDERTOWN CASINO
SPECIAL USE PERMIT
CIVIL SITE PLAN**

805 ROBERTA LANE, SUITE 104, SPARKS, NV 89421
 (775) 339-3351 FAX: (775) 339-3352
 www.odysseyeng.com

odyssey ENGINEERING INCORPORATED

SCALE
HORIZ. VERT.



GENERAL NOTES

- 1) ALL PLANTING AND IRRIGATION SHALL BE INSTALLED PER LOCAL GOVERNING CODES.
 - TREES
 - DECIDUOUS TREES SHALL HAVE A MINIMUM CALIPER OF 2 INCHES.
 - EVERGREEN TREES SHALL HAVE A MINIMUM HEIGHT OF 7 FEET.
 - ADDITIONAL TREES, BEYOND THOSE REQUIRED BY CODE, MAY BE REDUCED IN SIZE AT INSTALLATION.
- 3) FINAL PLANT SELECTION AND LAYOUT WILL BE BASED ON SOUND HORTICULTURAL PRACTICES RELATING TO MICRO-CLIMATE, SOIL, AND WATER REGIMES. ALL TREES WILL BE STAKED SO AS TO REMAIN UPRIGHT AND PLUMB FOLLOWING INSTALLATION. PLANT SIZE AND QUALITY AT TIME OF PLANTING WILL BE PER THE AMERICAN STANDARD FOR NURSERY STOCK (ANSI Z60.1-1990).
- 4) ALL SHRUB BEDS WILL RECEIVE 4" DEPTH MULCH WITH WEED CONTROL.
- 5) ALL LANDSCAPING WILL BE AUTOMATICALLY IRRIGATED. CONTAINER PLANTINGS WILL BE DRIP IRRIGATED BASED ON THE SPECIFIC HORTICULTURAL REQUIREMENTS OF EACH SPECIES. A REDUCED-PRESSURE-TYPE BACKFLOW PREVENTOR WILL BE PROVIDED ON THE IRRIGATION SYSTEM AS REQUIRED PER CODE.
- 6) PLAN IS CONCEPTUAL. PLANT QUANTITIES INDICATED ARE PER CITY OF WASHOE COUNTY CODE REQUIREMENTS. PLANT LOCATIONS, FINAL SPECIES SELECTION, AND SIZE AT PLANTING SHALL BE DETERMINED DURING DEVELOPMENT OF THE FINAL CONSTRUCTION DOCUMENTS.

LANDSCAPE DATA - PHASE 1 & 2

SITE AREA = 176,184 SQ FT (12.37 ACRES)
 APN: 081-140-16

ZONING: TC (TOURIST COMMERCIAL)

REQUIRED LANDSCAPE AREA = 35,237 SQ FT (20% OF TOTAL SITE AREA)

PROVIDED LANDSCAPE AREA = 35,913 SQ. FT. MIN.

- PROPOSED LANDSCAPE AREA: 5,636 SQ. FT.
- (E) ONSITE LANDSCAPE AREA: 29,833 SQ. FT.
- (E) R.O.W. LANDSCAPE AREA: 1,644 SQ. FT.

TREES REQUIRED = 101

- LANDSCAPE TREES = 72
- ONE TREE PER 300 SQ FT OF REQUIRED LANDSCAPE AREA
- PARKING TREES = 23
- ONE TREE PER 10 PARKING SPACES (2/1 SPACES PROVIDED)
- TREE PENALTY: REPLACE ONE 12" CALIPER EVERGREEN TREE = 6 AT 2" CAL.



TREES PROVIDED = 99 MIN.

- PROPOSED TREES = 35
- EXISTING TREES TO REMAIN = 64

SHRUBS REQUIRED = 570 MIN

- 6 SHRUBS PER REQUIRED TREE

PLANT LEGEND

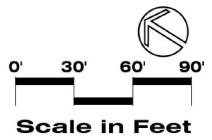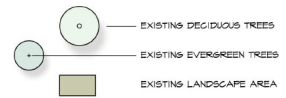

No.	Revision Date

LA No: 191-094-02-22
 Designed: RWH
 Drawn: ANH
 Checked: RWH
 Date: 04/10/2023



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- (E) R.O.W. LANDSCAPE AREA: 1,644 SQ. FT.

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- LANDSCAPE TREES = 72
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- PARKING TREES = 23
- ONE TREE PER 10 PARKING SPACES (231 SPACES PROVIDED)
- TREE PENALTY: REPLACE ONE 12" CALIPER EVERGREEN TREE = 6 AT 2" CAL.



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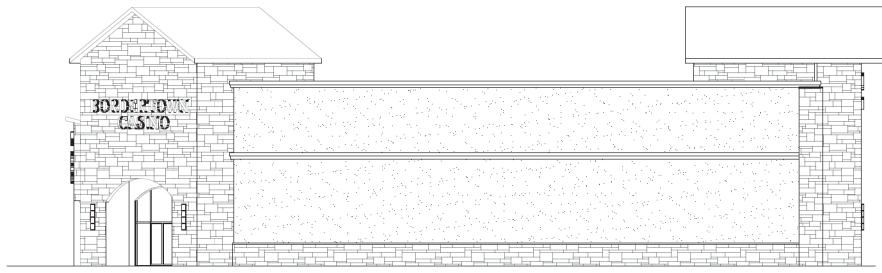
- 6 SHRUBS PER REQUIRED TREE

PLANT LEGEND




No.	Revision	Date

LA No: 191-094-02-22
 Designed: RWH
 Drawn: ANH
 Checked: RWH
 Date: 04/07/2023

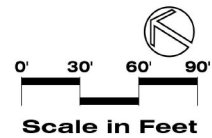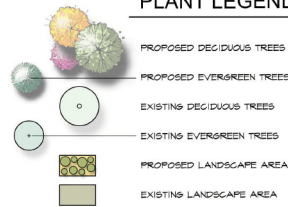

- T.O. ROOFLINE 47'-2"
- HIGH PARAPET 33'-0"
- HIGH ROOF 29'-0"
- LOW PARAPET 20'-0"
- 2ND FLOOR 19'-0"
- LOW ROOF 18'-0"
- B.O. OVER HANG 12'-0"
- T.O. STONE WAINSCOT 4'-0"
- 1ST FLOOR 0'-0"

1 EXTERIOR ELEVATION - EAST
SCALE: 3/32"=1'-0"

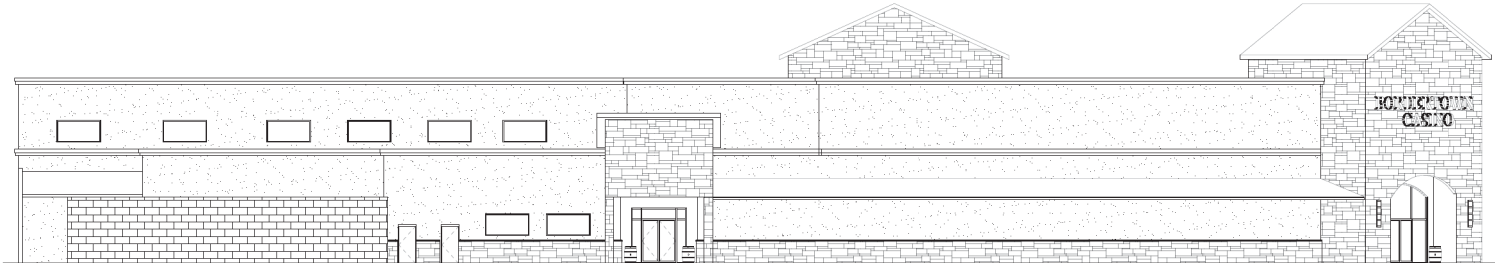

- T.O. ROOFLINE 47'-2"
- HIGH PARAPET 33'-0"
- HIGH ROOF 29'-0"
- LOW PARAPET 20'-0"
- 2ND FLOOR 19'-0"
- LOW ROOF 18'-0"
- B.O. OVER HANG 12'-0"
- T.O. STONE WAINSCOT 4'-0"
- 1ST FLOOR 0'-0"

2 EXTERIOR ELEVATION - SOUTH
SCALE: 3/32"=1'-0"

Revisions		
△	Date	Revision



PROJECT NAME
Borderline Casino Expansion
 19575 US-395
 Reno, NV 89508

DRAWING TITLE
**Exterior Elevation
 Phase 1 + Phase 2**



DATE:
April 7, 2023
 SHEET:
A6.2

Revisions		
△	Date	Revision




Approved For Submittal Only
 Not To Be Used For Construction
 Without Written Approval From
 The Architect

PROJECT NAME
Bortertown Casino Expansion
 19575 US-395
 Reno, NV 89508

DRAWING TITLE
**Exterior Elevation
 Phase 1 + Phase 2**


DATE
 April 7, 2023
 SHEET:

A6.3

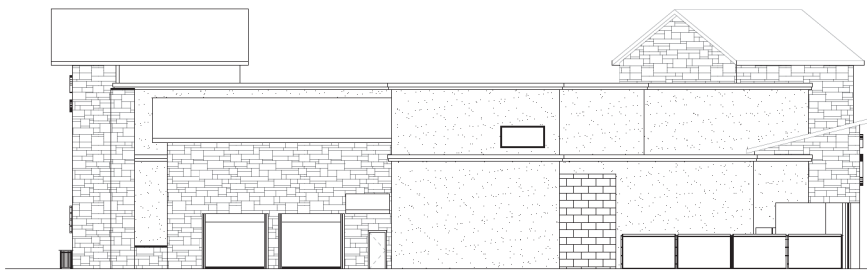

- T.O. POPOUT 47'-2"
- HIGH PARAPET 33'-0"
- HIGH ROOF 29'-0"
- LOW PARAPET 20'-0"
- 2ND FLOOR 18'-0"
- LOW ROOF 16'-0"
- B.O. OVER HANG 12'-0"
- T.O. STONE WAINSCOT 4'-0"
- 1ST FLOOR 0'-0"

3 EXTERIOR ELEVATION - WEST
 SCALE: 3/32"=1'-0"

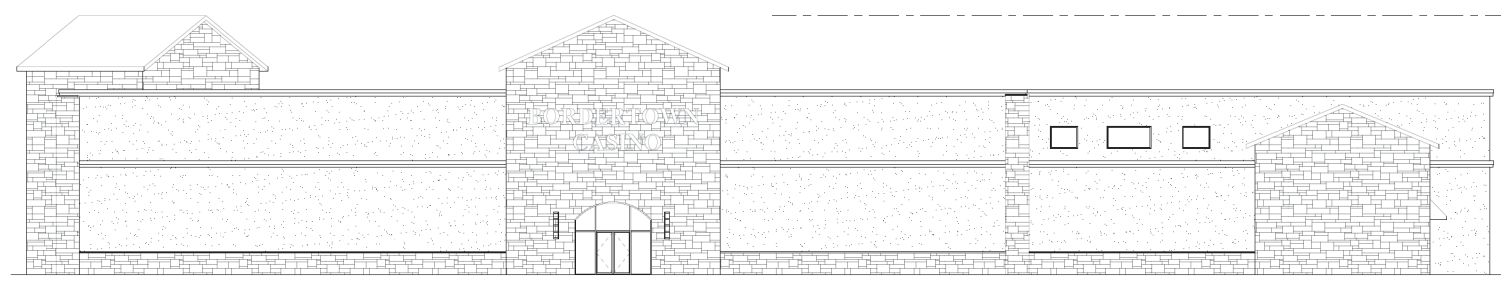

- T.O. POPOUT 47'-2"
- HIGH PARAPET 33'-0"
- HIGH ROOF 29'-0"
- LOW PARAPET 20'-0"
- 2ND FLOOR 18'-0"
- LOW ROOF 16'-0"
- B.O. OVER HANG 12'-0"
- T.O. STONE WAINSCOT 4'-0"
- 1ST FLOOR 0'-0"

4 EXTERIOR ELEVATION - NORTH
 SCALE: 3/32"=1'-0"

Revisions	
△	Date Revision



PROJECT NAME:
Bordertown Casino Expansion
 19575 US-395
 Reno, NV 89508

DRAWING TITLE:
Signage Plan
Phase 1 + Phase 2





DATE:
APRIL 7, 2023
 SHEET:
A7.0

SIGNAGE

BUILDING FRONTAGE: 168'
ALLOWED SIGNAGE: 420 SF, 4 TOTAL BUILDING SIGNS

PROPOSED SIGNAGE: 3 TOTAL
 - FRONT ENTRANCE: 240 SF
 - BACK/SIDE ENTRANCE: 144 SF
 - RESTAURANT ENTRANCE: 36 SF

PROPOSED SIGNAGE WILL ADHERE TO ALL REQUIRED CODE REQUIREMENTS INCLUDING ILLUMINATION, SIZE, TYPE, LOCATION ETC.

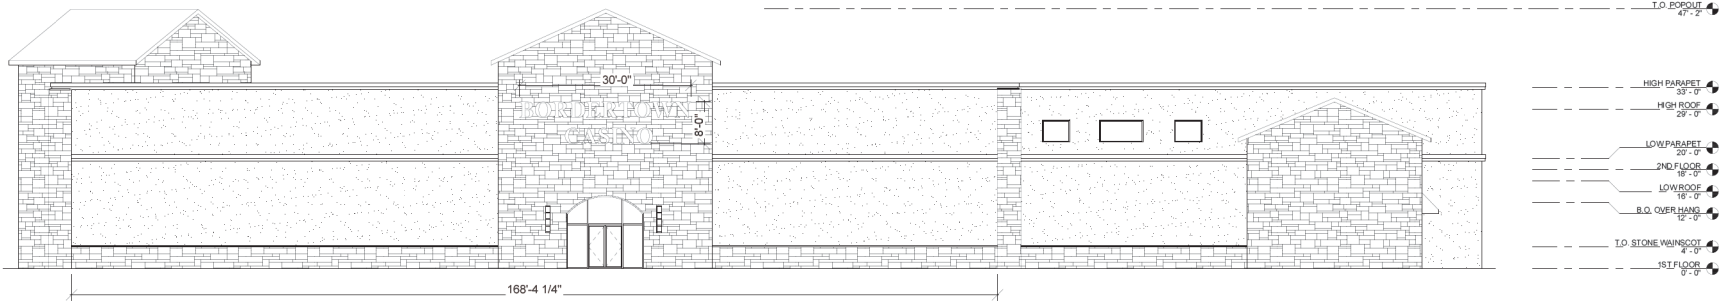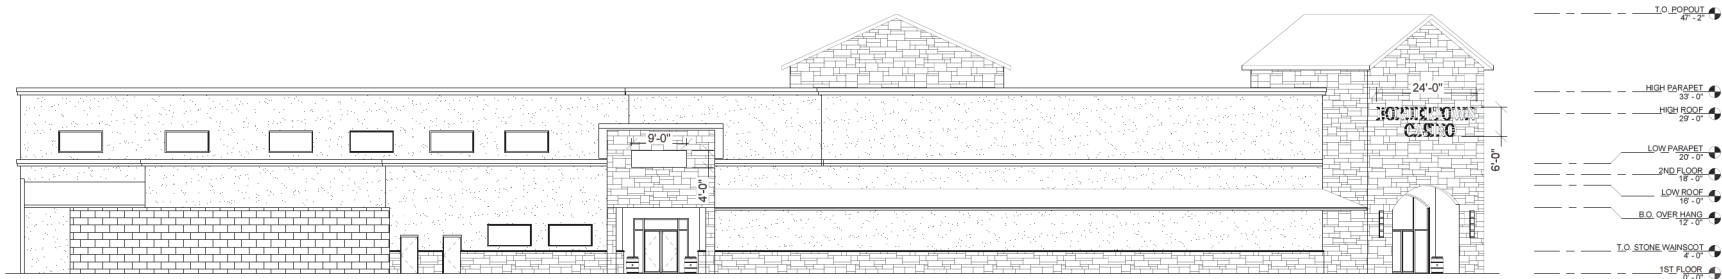











LIGHTING FIXTURE SCHEDULE

LIGHTING FIXTURE CATALOG NUMBERS ARE SERIES TYPE ONLY. PROVIDE TRIMS, BALLASTS, MOUNTING EQUIPMENT, FITTINGS AND LAMPS AS REQUIRED BY THE SPECIFICATIONS AND PROJECT CONDITIONS FOR A COMPLETE INSTALLATION. THIS IS NOT A STANDALONE SCHEDULE, AND FIXTURES MUST INCORPORATE ALL WORK INDICATED OR IMPLIED THROUGHOUT THE DRAWINGS AND SPECIFICATIONS.

TYPE	SYMBOL	SKETCH	DESCRIPTION AND MANUFACTURER
SY	(E)		EXISTING HID, SINGLE HEAD METAL HALIDE WITH TYPE 2 OPTICS MOUNTED ON A 25'-0" TALL, 4" SQUARE STEEL POLE. DARK BRONZE FINISH. MOUNTING HEIGHT: 27'-6" LAMP: (1) 400W PSMH HOUSING: 200V MANUFACTURER: VISIONARE: AME-2-T2-400M-(2)208-80A10-BZ SUBSTITUTIONS: ○ OR EQUAL ☒ SUBJECT TO REVIEW ○ NO EQUAL
SY	(E)		EXISTING HID, THIN HEAD METAL HALIDE WITH TYPE 2 OPTICS MOUNTED ON A 25'-0" TALL, 4" SQUARE STEEL POLE. DARK BRONZE FINISH. MOUNTING HEIGHT: 27'-6" LAMP: (1) 400W PSMH HOUSING: 200V MANUFACTURER: VISIONARE: AME-2-T2-400M-(2)208-80A10-BZ SUBSTITUTIONS: ○ OR EQUAL ☒ SUBJECT TO REVIEW ○ NO EQUAL

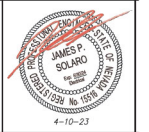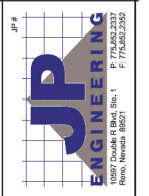

American HID Project Name: _____ Catalog Number: _____ Type _____

Dimensional Drawings

Fixture	A	B	C	Stroke	Max. Watts	Lbs
AME-1	14"	14"	10"	2"	175 W	55
AME-2	19"	19"	12"	2"	400 W	50
AME-3	23"	23"	13"	2"	1000 W	70
AME-4	23"	23"	15"	2"	1000 W	65

The American HID fixture features the most advanced lighting technology system available today. Vision™ is a patented, revolutionary reflector system unlike any other. The flat lens, vertical lens, 183 luminaire fixture is Dieh-Sily certified to resist light trespass, glare and light pollution for neighborhood friendly outdoor lighting. Convex glass lens is available when required.

The clean, compact housing style features a decorative reveal available in complementary or contrasting colors. Computerized precision machinery and quality materials ensure manufacturing to the highest industry standards.

American is a proven performer for auto dealerships, shopping centers, parking lots and general area lighting. A wide selection of light sources from 100 through 1000 watts are offered in Metal Halide, High Pressure Sodium and Fluorec. Start latest raise lamp when provides greatest efficiency, longest maintenance and color.

American is offered in five enclosure sizes and five distribution patterns including a special forward throw TIA reflector for auto dealership front line lighting. Vision™ Reflector System allows the use of fewer fixtures and poles with wider spacings, providing substantial equipment, installation and energy cost savings.

American is a proven performer for auto dealerships, shopping centers, parking lots and general area lighting. A wide selection of light sources from 100 through 1000 watts are offered in Metal Halide, High Pressure Sodium and Fluorec. Start latest raise lamp when provides greatest efficiency, longest maintenance and color.

Model	Optics	Wattage	Source	Voltage	Mounting	Finish/Stripe	Options
AME-1 Flat Glass Only	Type II (17)	100 (160) 150 (165) 175 (175)	PS HPS PS HPS PS	120 120 120	Bolt-On Arm B ¹ (BOA-B)	Black (BK) White (WH) Forest Green (FG) Silver (SI) Grey (GR) Silver Metallic (SL) Custom Color (CC) Stripe Color (SC) Blue Metallic (BM) Red Metallic (RM) Silver Metallic (SM) Black Metallic (BK) White Metallic (WM) Charcoal Metallic (CM)	Rhodo® & Fluorec® PHOSPHOR PC(R200) PC(R277) PC(R280) Photo Spectrable (PSP) see literature Button Top Phosphor (BT) see literature Quartz Halogen (LH) E-90 (E90) (E91) (E92) (E93) (E94) (E95) (E96) (E97) (E98) (E99) Internal Light Shield (ILS) Chromax® Start Lens (CL) Round Pole Pipe Adaptor (RPP) Cast Wall Plate (CWP)
AME-2 Flat Glass Convex Lens Optional	Type III (18) Type IV (19) Type V (20)	200 (260) 320 (240) 400 (400)	PS HPS PS HPS PS HPS	240 240 240	Spider Mount TIA ²	White (WH) Forest Green (FG) Silver (SI) Grey (GR) Silver Metallic (SL) Custom Color (CC) Stripe Color (SC) Blue Metallic (BM) Red Metallic (RM) Silver Metallic (SM) Black Metallic (BK) White Metallic (WM) Charcoal Metallic (CM)	Rhodo® & Fluorec® PHOSPHOR PC(R200) PC(R277) PC(R280) Photo Spectrable (PSP) see literature Button Top Phosphor (BT) see literature Quartz Halogen (LH) E-90 (E90) (E91) (E92) (E93) (E94) (E95) (E96) (E97) (E98) (E99) Internal Light Shield (ILS) Chromax® Start Lens (CL) Round Pole Pipe Adaptor (RPP) Cast Wall Plate (CWP)
AME-3 Flat Glass Convex Lens Optional	Type III (18) Type IV (19) Type V (20)	700 (700) 1000 (1000) 1000 (1000)	PS HPS PS HPS PS HPS	480 480 480	Wall Mount TIA ²	White (WH) Forest Green (FG) Silver (SI) Grey (GR) Silver Metallic (SL) Custom Color (CC) Stripe Color (SC) Blue Metallic (BM) Red Metallic (RM) Silver Metallic (SM) Black Metallic (BK) White Metallic (WM) Charcoal Metallic (CM)	Rhodo® & Fluorec® PHOSPHOR PC(R200) PC(R277) PC(R280) Photo Spectrable (PSP) see literature Button Top Phosphor (BT) see literature Quartz Halogen (LH) E-90 (E90) (E91) (E92) (E93) (E94) (E95) (E96) (E97) (E98) (E99) Internal Light Shield (ILS) Chromax® Start Lens (CL) Round Pole Pipe Adaptor (RPP) Cast Wall Plate (CWP)
AME-4 Flat Glass Only	Type V (20)	575 (575) 750 (750) 775 (775) 1000 (1000) 1000 (1000)	PS HPS PS HPS PS HPS MH PS HPS MH PS HPS	480 480 480 480 480	Wall Mount TIA ²	White (WH) Forest Green (FG) Silver (SI) Grey (GR) Silver Metallic (SL) Custom Color (CC) Stripe Color (SC) Blue Metallic (BM) Red Metallic (RM) Silver Metallic (SM) Black Metallic (BK) White Metallic (WM) Charcoal Metallic (CM)	Rhodo® & Fluorec® PHOSPHOR PC(R200) PC(R277) PC(R280) Photo Spectrable (PSP) see literature Button Top Phosphor (BT) see literature Quartz Halogen (LH) E-90 (E90) (E91) (E92) (E93) (E94) (E95) (E96) (E97) (E98) (E99) Internal Light Shield (ILS) Chromax® Start Lens (CL) Round Pole Pipe Adaptor (RPP) Cast Wall Plate (CWP)

EPA Data

Fixture with Arm	1.4	2.4	2.8	3.8	3.3	4.5	1.7
AME-1	3.2	4.9	6.4	6.0	6.1	7.1	2.8
AME-2	3.2	5.3	6.4	6.7	5.4	10.2	2.7
AME-3	3.4	6.2	8.8	9.2	7.6	10.9	3.9

1840 America Photo Optics Corp. (A 1002)
14150 E. 10th St. Suite 100
Denver, CO 80231
www.americain.com

American (H) (E)

Housing

- All housings are manufactured using technologically advanced computerized numerical control (CNC) machinery. Precision precision and formed from one-piece, corrosion-resistant aluminum, with bonded external finish.
- The computerized CNC machinery enables all American housings to be constructed quickly, efficiently and adhering to exacting ISO 9002 standards. All external hardware is stainless steel.

Lens and Door Assembly

- Removable tripod door assembly is CNC precision, machined and formed from one-piece, corrosion-resistant aluminum with captive stainless steel fasteners.
- The standard lens is a clear, tempered flat glass, secured by galvanized lens retainers, and sealed with silicone gaskets to provide complete weather and insect protection.
- All optional convex glass lens is available when required for AME-2, convex lens is standard on AME-3.

Vision™ Optical System

- Reflects a precision CNC cut and bent, multi-faceted, segmented, highly efficient, 85% reflective aluminum. Available in five distribution patterns.
- TAA automotive reflector is field rotatable.
- Topless reflector entry.

Quick-Change™ Finish

- The finish is Dual-Color™ finished, chemically pretreated through a multiple-stage washer, electrostatically applied, thermocured, polyester powder coat finish, with a minimum of 3.5 millimeter thickness. Finish is oven-baked at 400°F to promote maximum adhesion and finish hardness. All finishes are available in standard and custom colors.
- Finish is guaranteed for two (2) years.

AMERICAN-BOLUX CURVE

TYPE III
FLAT GLASS OPTICS
200 WATT

Scale: 1 Square = 60"
Light Loss Factor = 0.9
Mounting Height = 25'
Mounting Pole = 4" Dia

AMERICAN-2 BOLUX CURVE

TYPE II
FLAT GLASS OPTICS
400 WATT

Scale: 1 Square = 36"
Light Loss Factor = 0.9
Mounting Height = 25'
Mounting Pole = 4" Dia

Bolt-On Arm Detail

Cast Wall Plate

Spider Mount Detail

EPA Data

Fixture with Arm	1.4	2.4	2.8	3.8	3.3	4.5	1.7
AME-1	3.2	4.9	6.4	6.0	6.1	7.1	2.8
AME-2	3.2	5.3	6.4	6.7	5.4	10.2	2.7
AME-3	3.4	6.2	8.8	9.2	7.6	10.9	3.9


1840 America Photo Optics Corp. (A 1002)
14150 E. 10th St. Suite 100
Denver, CO 80231
www.americain.com

SPECIAL USE PERMIT
BORDERTOWN CASINO
WASHOE COUNTY, NEVADA

REVISIONS

SHEET TITLE
SYMBOL LIST AND SPECIFICATIONS

DRAWN: MT
CHECKED: JS
DATE: 10 APRIL 2023
JOB NUMBER: JP #22202
CITY: APRIL


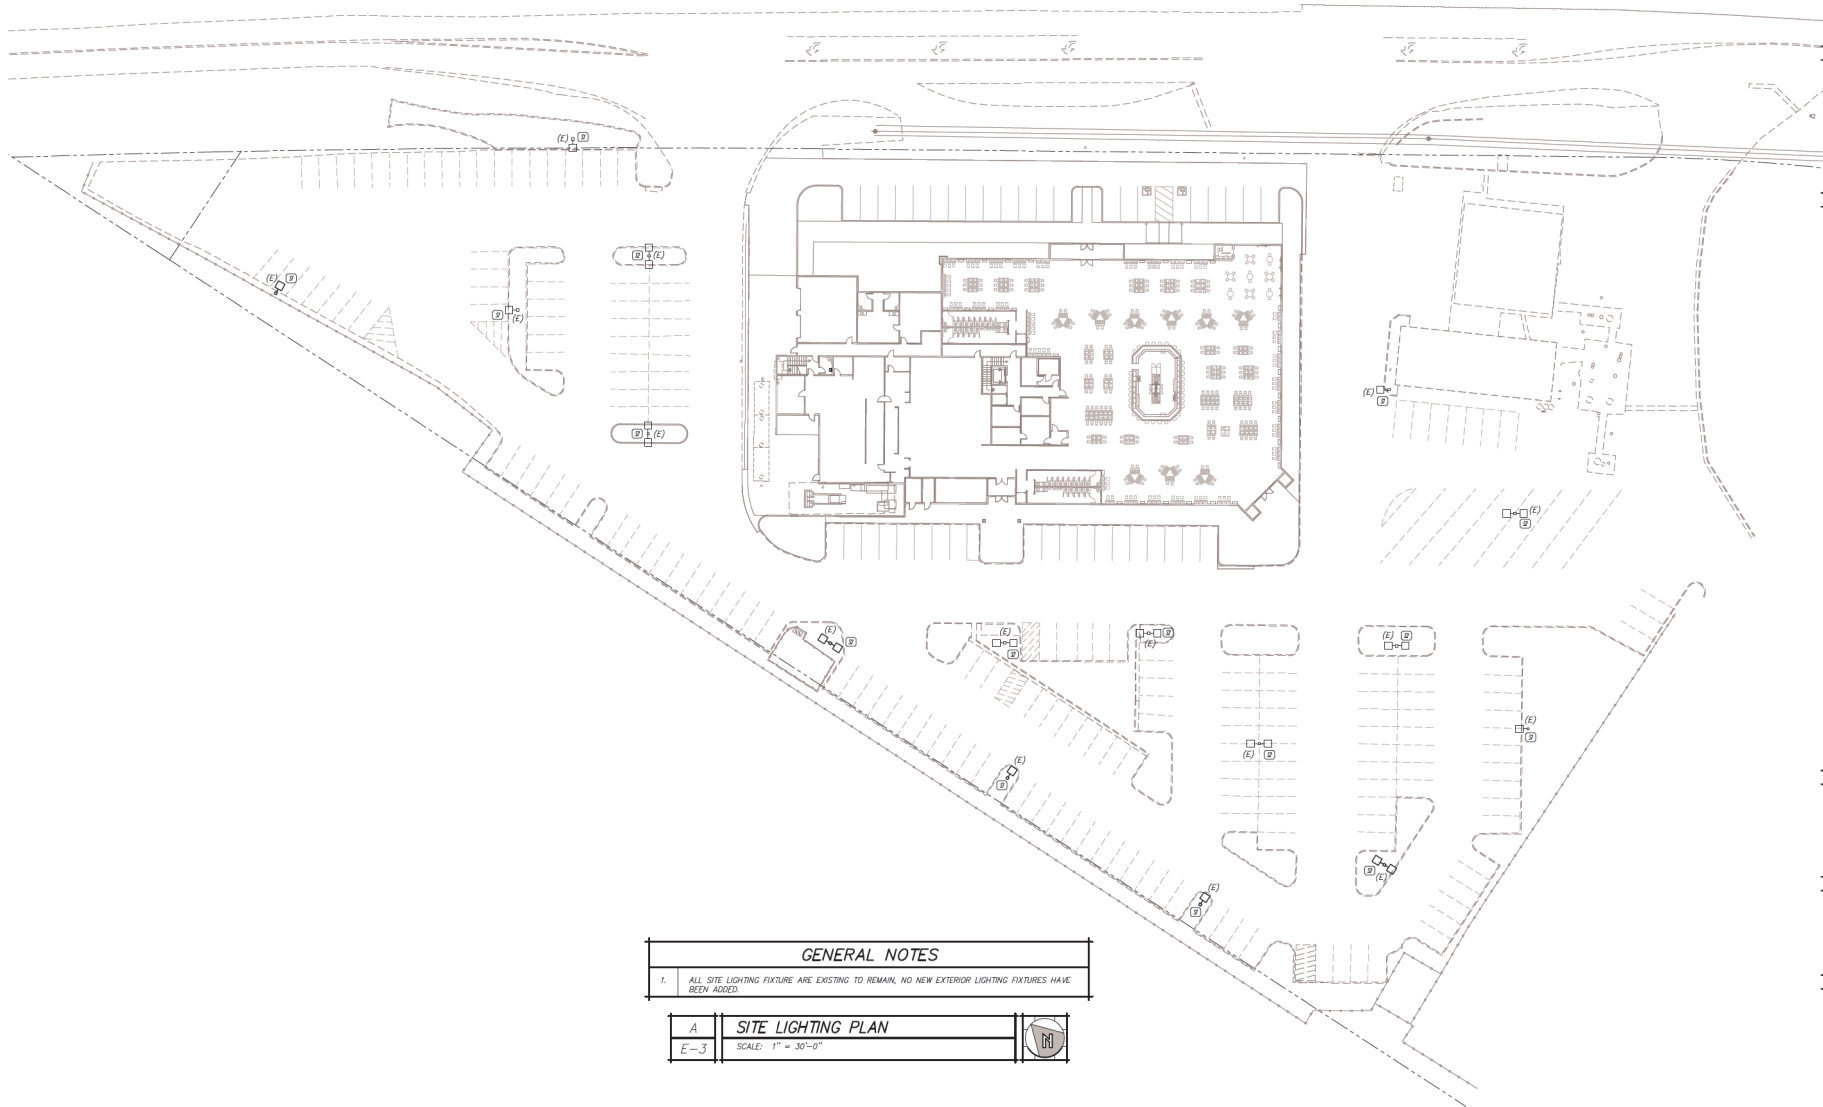


GENERAL NOTES

1. ALL SITE LIGHTING FIXTURE ARE EXISTING TO REMAIN, NO NEW EXTERIOR LIGHTING FIXTURES HAVE BEEN ADDED.

A **SITE LIGHTING PLAN**

E-3 SCALE: 1" = 30'-0"

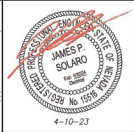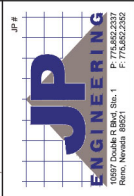


SPECIAL USE PERMIT
BORDERTOWN CASINO
WASHOE COUNTY, NEVADA

REVISIONS

SHEET TITLE
SITE LIGHTING PLAN

DRAWN: MT
CHECKED: JS
DATE: 10 APRIL 2023
JOB NUMBER: JP #22202
CITY APPROVAL:


E-3

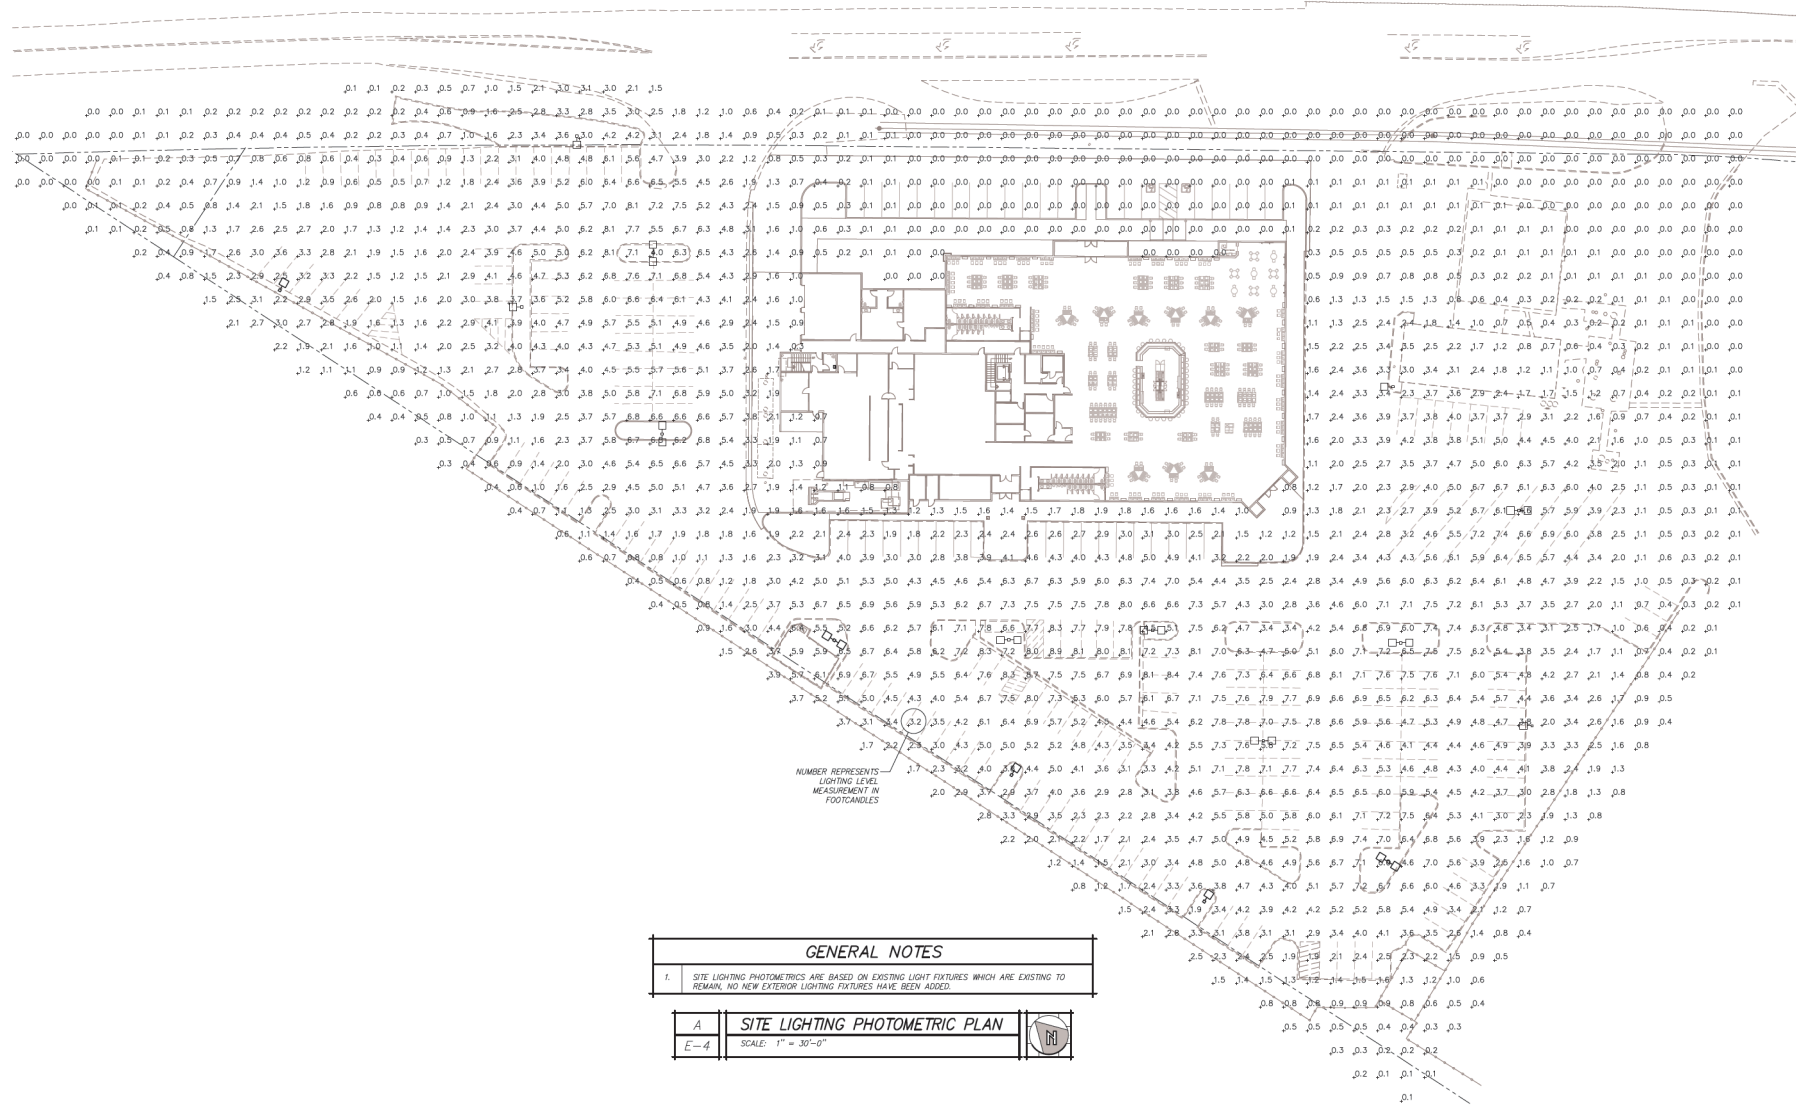

NUMBER REPRESENTS LIGHTING LEVEL MEASURED IN FOOTCANDLES

GENERAL NOTES

- SITE LIGHTING PHOTOMETRICS ARE BASED ON EXISTING LIGHT FIXTURES WHICH ARE EXISTING TO REMAIN. NO NEW EXTERIOR LIGHTING FIXTURES HAVE BEEN ADDED.

A	SITE LIGHTING PHOTOMETRIC PLAN	
E-4	SCALE: 1" = 30'-0"	